

Full Size or Largest Size Plans
Site Plan
Landscape Plan
Elevations

# PROJECT TEAM

# PROJECT OWNER

1355 WEST UNIVERSITY DRIVE ADDRESS: CITY, STATE, ZIP: MESA, AZ 85201-5419 SAQ CONTACT NAME: SHAH KHALID CONSTRUCTION CONTACT NAME: ROBERT F HOFRICHTER

TOWER OWNER

2000 CORPORATE DRIVE CITY, STATE, ZIP: CANONSBURG, PA 15317

CROWN CASTLE SITE NAME: SCOTTSDALE PIMA INN SCOTTSDALE PIMA INN BU NUMBER:

APPLICATION NUMBER: 482635 JDE JOB NUMBER: 561664

AE PROJECT MANAGER: CONSTRUCTION MANAGER:

APPLICATION PROJECT MANAGER: GABRIEL DALEY (480) 735-6929 ANDREW MAGOON (602) 845-1783 TROY BOSWORTH (480) 735-6905

A&E FIRM:

TELCYTE INFRASTRUCTURE SERVICES 2227 W. PECOS ROAD SUITE 4

CITY, STATE, ZIP: CHANDLER, AZ 85227 cwolfe@telcyte.com

# **REFERENCE DOCUMENTS:**

STRUCTURAL ANALYSIS: Paul J. Ford & Company

MOUNT ANALYSIS: BY OTHERS

# **INSTALLER NOTE:**

TOWER DOES NOT HAVE CLIMBING FACILITIES - MANLIFT REQUIRED FOR ELEVATED WORK.

# GENERAL NOTES

# DO NOT SCALE DRAWINGS

CONTRACTOR SHALL VERIFY ALL PLANS AND EXISTING DIMENSIONS AND CONDITIONS ON THE JOB SITE AND SHALL IMMEDIATELY NOTIFY THE ARCHITECT/ENGINEER IN WRITING OF ANY DISCREPANCIES BEFORE PROCEEDING WITH THE WORK OR BE RESPONSIBLE FOR

FACILITY IS UNMANNED AND NOT FOR HUMAN HABITATION. A TECHNICIAN WILL VISIT THE SITE AS REQUIRED FOR ROUTINE MAINTENANCE. THE PROJECT WILL NOT RESULT IN ANY SIGNIFICANT DISTURBANCE OR EFFECT ON DRAINAGE; NO SANITARY SEWER SERVICE, POTABLE WATER, OR TRASH DISPOSAL IS REQUIRED AND NO COMMERCIAL SIGNAGE IS

CONTACT INSPECTION DEPARTMENT IN SCOTTSDALE FOR PRE-CON MEETING.


PRE-CONSTRUCTION MEETING REQUIRED, CONTACT CITY OF SCOTTSDALE INSPECTION SERVICES 480-312-5796.

# AZL00217 138903/380831 344401 SCOTTSDALE PIMA INN 7330 NORTH PIMA ROAD SCOTTSDALE, AZ 85258

FA: 10091225 USID: 10785

PTN: 3901A0J32E BWE, 3901A0BC3R LTE 5C -

AZL00217

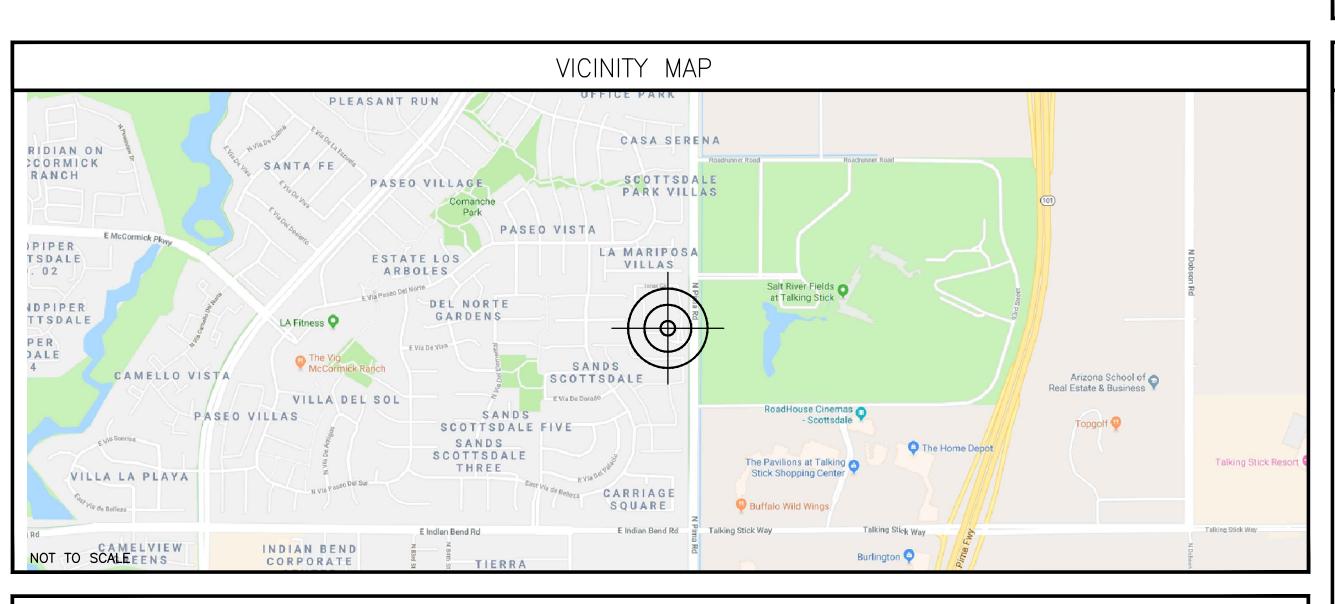

# DRIVING DIRECTIONS

FROM AT&T OFFICE: 1355 WEST UNIVERSITY DRIVE, MESA, AZ 85201-5419: HEAD EAST TOWARD W UNIVERSITY DR 226 FT, TURN LEFT TOWARD W UNIVERSITY DR 131 FT, TURN LEFT ONTO W UNIVERSITY DR 1.8 MI, TURN RIGHT ONTO N PRICE RD 0.5 MI, USE THE MIDDLE 2 LANES TO TAKE THE RAMP ONTO AZ-101 LOOP N 0.3 MI, MERGE ONTO AZ-101 LOOP N 7.0 MI, TAKE EXIT 44 FOR INDIAN BEND RD 0.3 MI, USE THE LEFT 2 LANES TO TURN LEFT ONTO TALKING STICK WAY 0.6 MI, TURN RIGHT ONTO N PIMA RD 0.4 MI, TURN LEFT ONTO INNER CIR 167 FT, TURN RIGHT TO STAY ON INNER CIR. DESTINATION WILL BE ON THE LEFT 479 FT.

# CODE COMPLIANCE

BUILDING CODE: INTERNATIONAL BUILDING CODE 2015

ELECTRICAL CODE: NATIONAL ELECTRICAL CODE 2014

THE DATE OF CONTRACT AWARD SHALL GOVERN THE DESIGN.

LIGHTNING PROTECTION CODE: NFPA 780 - 2014, LIGHTNING PROTECTION SYSTEM

SUBCONTRACTOR'S WORK SHALL COMPLY WITH ALL APPLICABLE NATIONAL, STATE, AND HABITATION. HANDICAPPED ACCESS NOT REQUIRED. LOCAL CODES AS ADOPTED BY THE LOCAL AUTHORITY HAVING JURISDICTION (AHJ) FOR

> FOR ANY CONFLICTS BETWEEN SECTIONS OF LISTED CODES AND STANDARDS REGARDING MATERIAL, METHODS OF CONSTRUCTION, OR OTHER REQUIREMENTS, THE MOST RESTRICTIVE REQUIREMENT SHALL GOVERN. WHERE THERE IS CONFLICT BETWEEN A GENERAL REQUIREMENT AND A SPECIFIC REQUIREMENT, THE SPECIFIC REQUIREMENT SHALL GOVERN.

THE LOCATION. THE EDITION OF THE AHJ ADOPTED CODES AND STANDARDS IN EFFECT O

# RFDS DATA

DESIGN PACKAGE BASED ON RF DATA SHEET

RFDS NAME: AZL00217 REVISION: 1.00 ISSUED: 01/09/2019 NUMBER OF SECTORS: 3 NUMBER OF ANTENNAS: 6 NUMBER OF TMAs: 4 NUMBER OF RRHs: 9 NUMBER OF FIBER/DC SQUIDS: 1 NUMBER OF DC SQUIDS: 1 NUMBER OF OPTICAL TRUNK CABLES: 1 NUMBER OF DC TRUNK CABLES: 4 NUMBER OF RF CABLES: 14 NUMBER OF RET CABLES: NUMBER OF WCS FILTER: 1

# APPROVALS LANDLORD: DATE: LANDLORD:

# JURISDICTIONAL APPROVAL

PROJECT DESCRIPTION

• PALM TO BE REFRONDED WITH 93 FRONDS: 60% 10 FT FRONDS, 40% 8 FT

• REPLACE (E) POWER PLANT W/(1) NEW NETSURE 512 -48VDC POWER PLANT

& (3) EA. HE 1.5KW -48VDC/+24VDC CONVERTER MODULES [NEQ15929].

INSTALL NEW VERTIV BATTERY CABINET. REMOVE EXISTING ALPHA CABINETS

REMOVE ALL EXISTING BATTERIES AND REPLACE WITH 4 STRINGS 170 AH

INSTALL (16) MARATHON M12V170FT BATTERIES I.E. (4) STRINGS @ -48VDC

[NEQ15917] OUTFITTED WITH (9) EA. HE 2KW -48VDC RECTIFIERS [NEQ15930]

. MONOPALM NOT TO BE LEFT "UNFRONDED" FOR ANY PERIOD OF TIME

THIS PROJECT WILL BE COMPRISED OF: CHANGES ON THE EXISTING MONOPALM:

DC POWER PLAN REVIEW:

• DC BREAKER;

A/C PANEL REVIEW:

• SEE PANEL SCHEDULE

NO WORK — OUTDOOR EQUIPMENT

• REMOVE (1) ANTENNA PER SECTOR, TOTAL OF (3)

• REPLACE (1) ANTENNA PER SECTOR, TOTAL OF (3)

CHANGES IN THE EXISTING AT&T EQUIPMENT ENCLOSURE AREA

(3) 50A AIRSCALE DUAL RRH B25/66 [NEQ.00710]

(3) 20A RRH 4X25 - WCS [NEQ.00466]

FOR OF À TOTAL OF 4.3 HRS OF BATTERY RESERVE.

(2) 60A FUSE PANEL [NEQ.00711]

• INSTALL (1) EA. NEW —48VDC PURCELL FLX21 CABINET

• REMOVE (1) RRH PER SECTOR, TOTAL OF (3)

• REPLACE (2) RRHs PER SECTOR, TOTAL OF (6)

• RELOCATE (1) RRH PER SECTOR, TOTAL OF (3)

(2) 15A 7705 SIAD [NEQ.00706]

(3) 150A UMTS [NEQ.00714]

(1) 100A BBU [NEQ.00187]

# ANY USE OR DISCLOSURE OTHER THAN AS IT RELATES



1355 WEST UNIVERSITY DRIVE MESA, AZ 85201-5419

THE INFORMATION CONTAINED IN THIS SET OF DRAWINGS IS PROPRIETARY & CONFIDENTIAL TO AT&T WIRELESS

AT&T WIRELESS IS STRICTLY PROHIBITED



2055 SOUTH STEARMAN DRIVE CHANDLER, AZ 85286

05/13/19 SCPT UPDATE 04/26/19 SUBMITTAL CD'S 03/18/19 SUBMITTAL CD'S REV. REVISION DESCRIPTION



PROJECT INFORMATION:

846027 AZL00217 SCOTTSDALE PIMA INN 7330 NORTH PIMA ROAD SCOTTSDALE, AZ 85258 MARICOPA COUNTY

DRAWN BY:	CHECKED BY:
APR	CW
SHEET TITLE:	
TIT	LE EET
SHEET NUMBER:	REV.:

SITE INFORMATION

LATITUDE: 33.5442472 LONGITUDE: -111.8923528 LAT./LONG. TYPE: NAD 83 **GROUND ELEVATION:** 1299.2' MSL 174-08-939 AREA OF CONSTRUCTION: **EXISTING** 

ZONING/JURISDICTION: CITY OF SCOTTSDALE

CURRENT ZONING:

UNMANNED TELECOMMUNICATIONS FACILITY EXISTING USE:


MARICOPA COUNTY


HANDICAP REQUIREMENTS: FACILITY IS UNMANNED AND NOT FOR HUMAN





CALL ARIZONA ONE CALL (800) 782-5348 CALL 3 WORKING DAYS BEFORE YOU DIG!



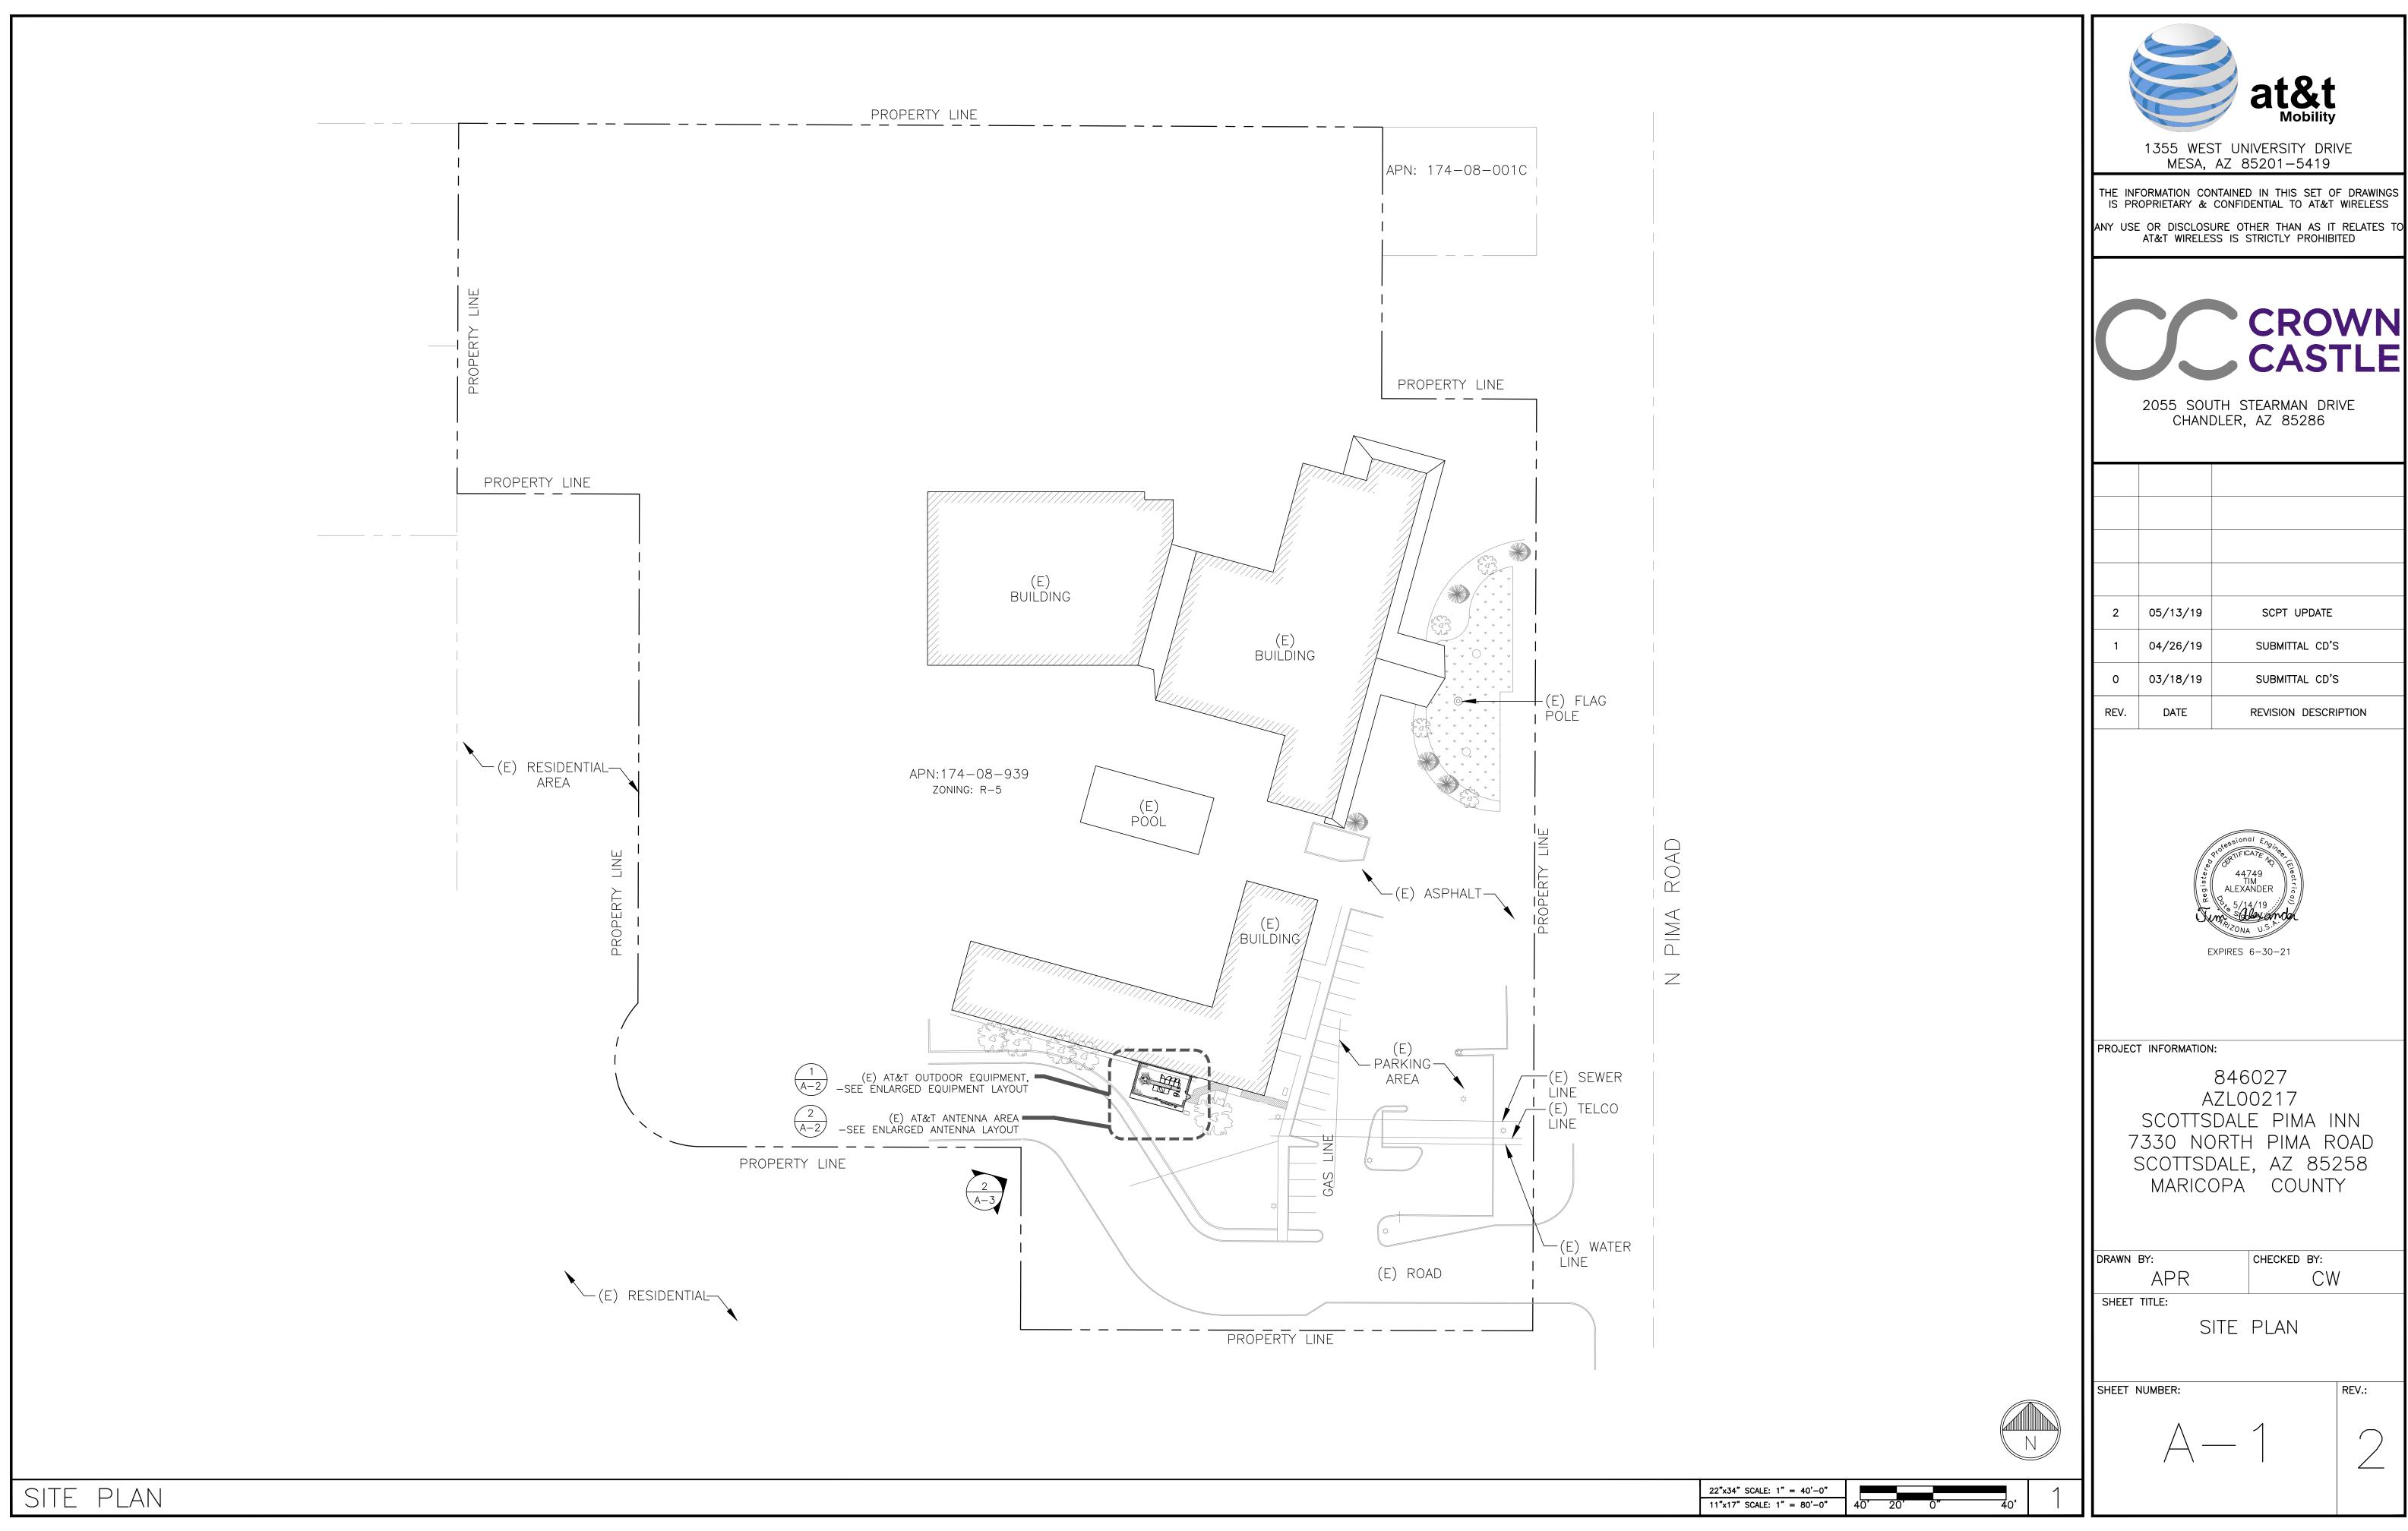

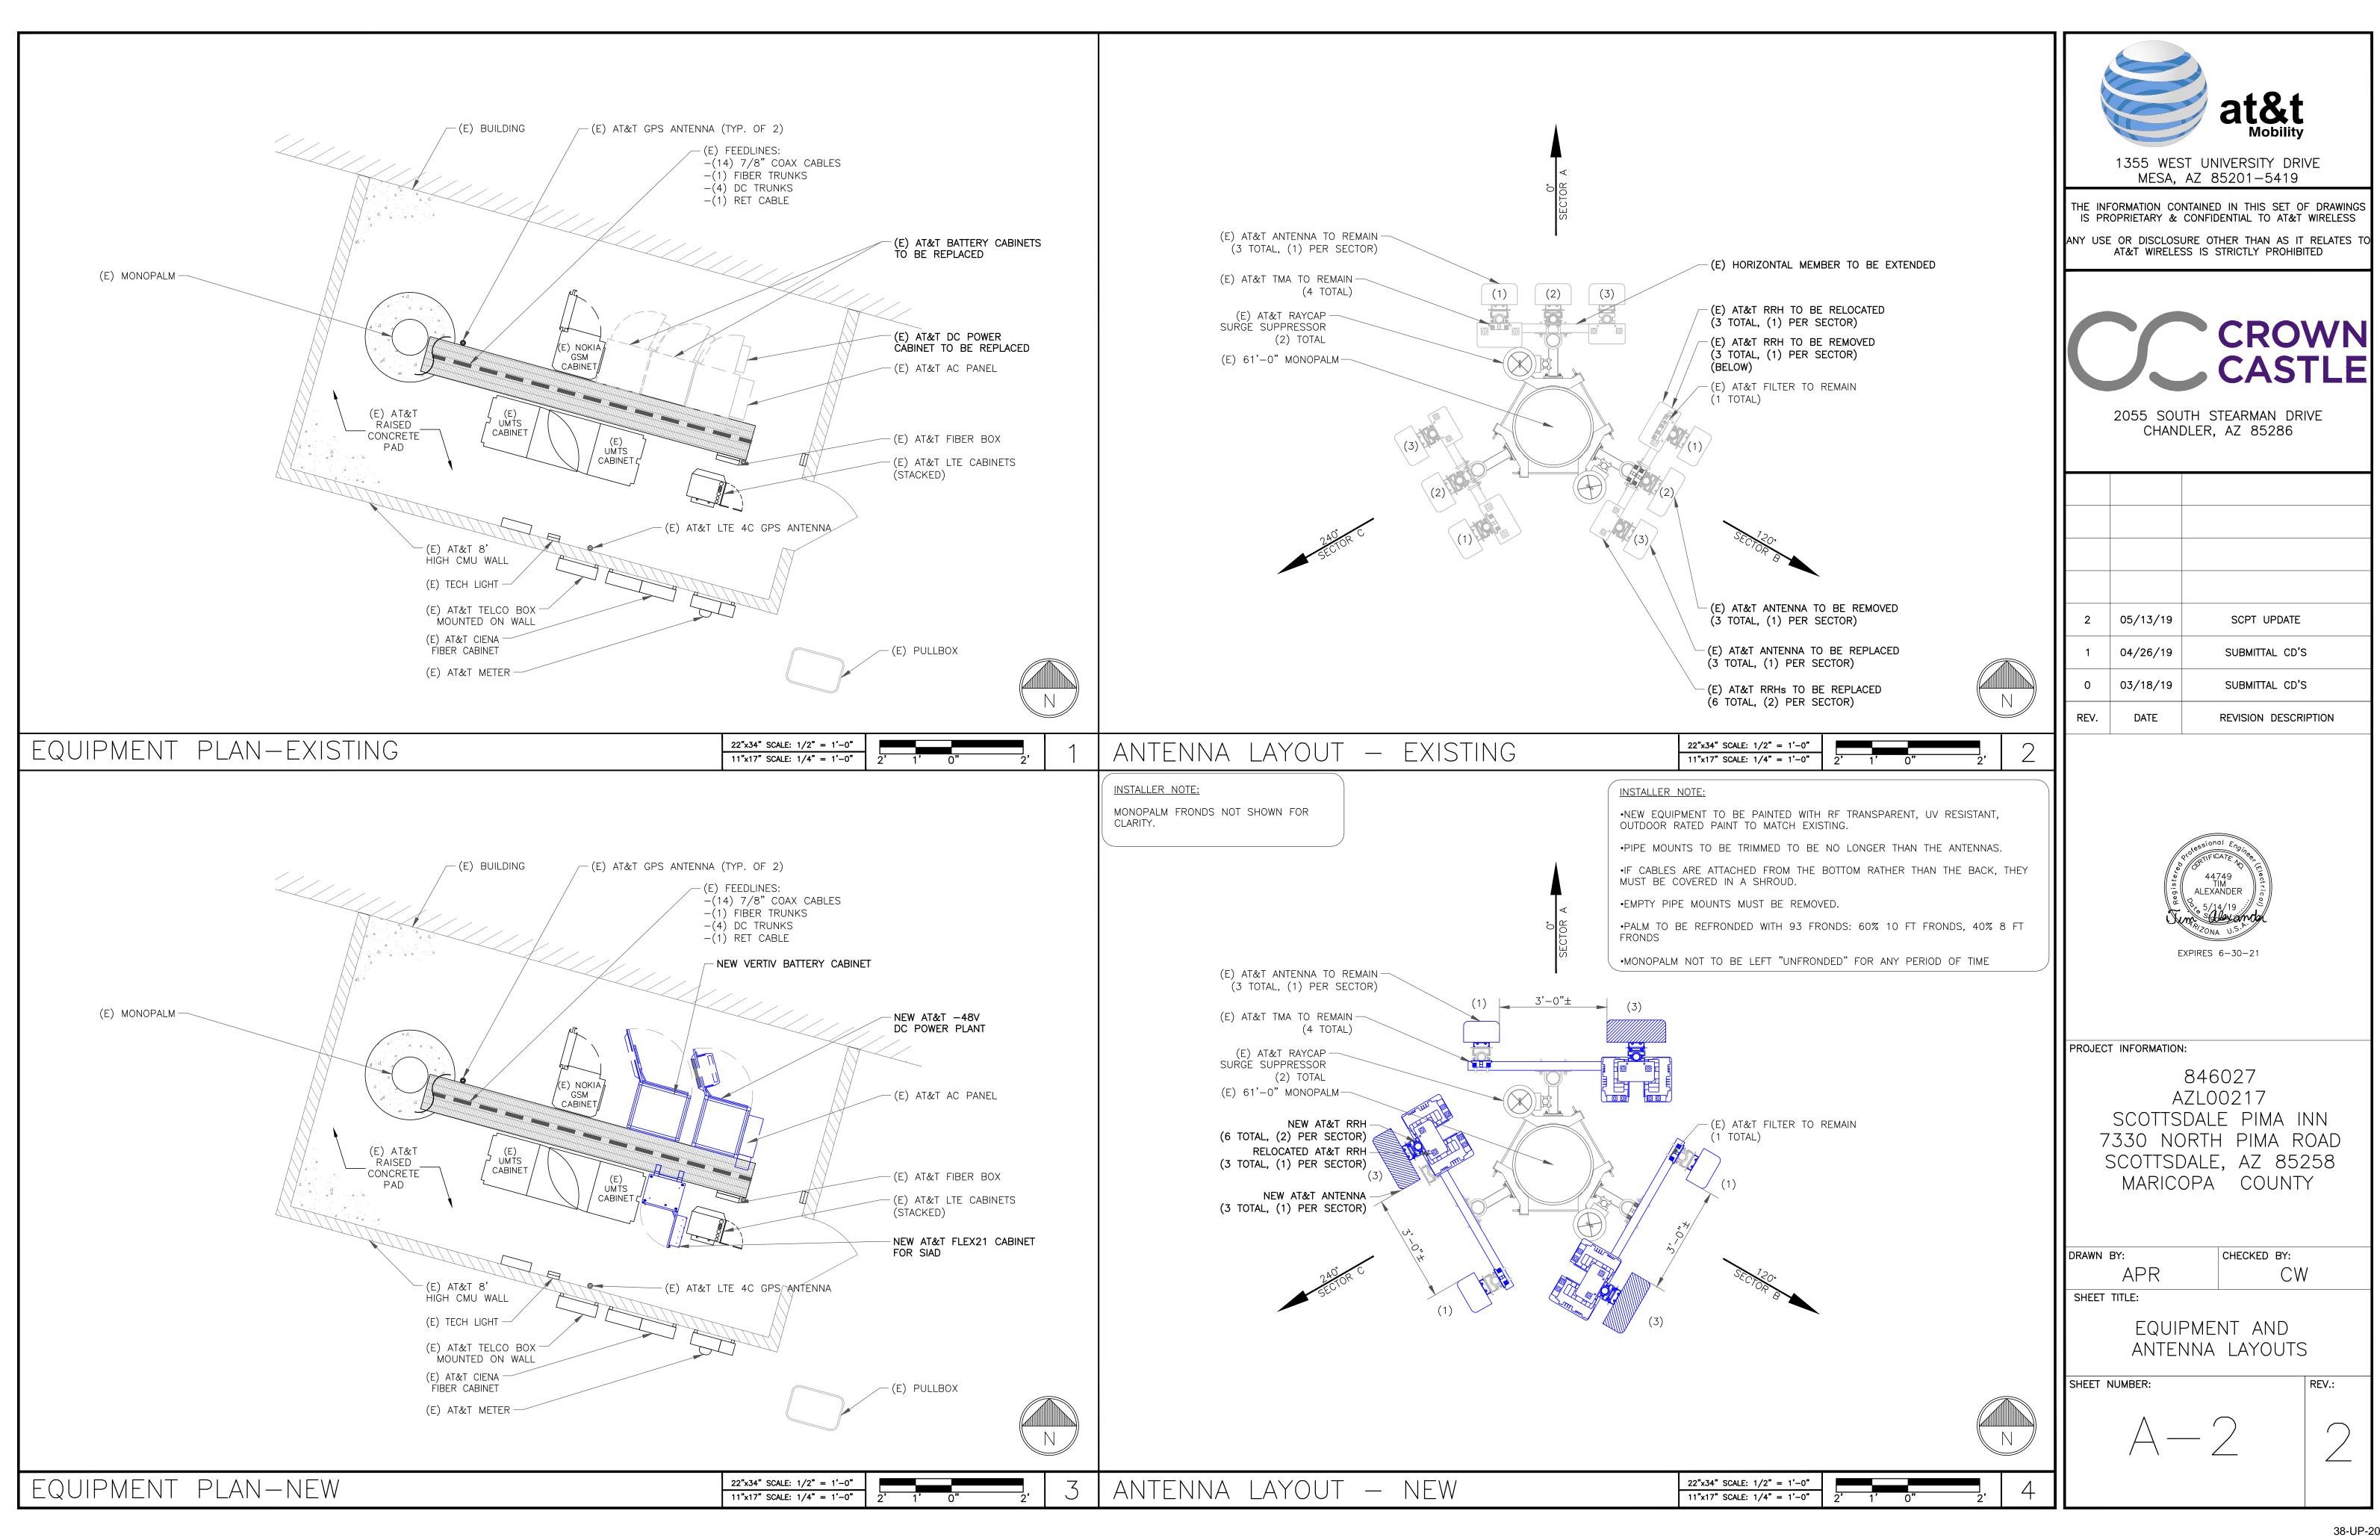


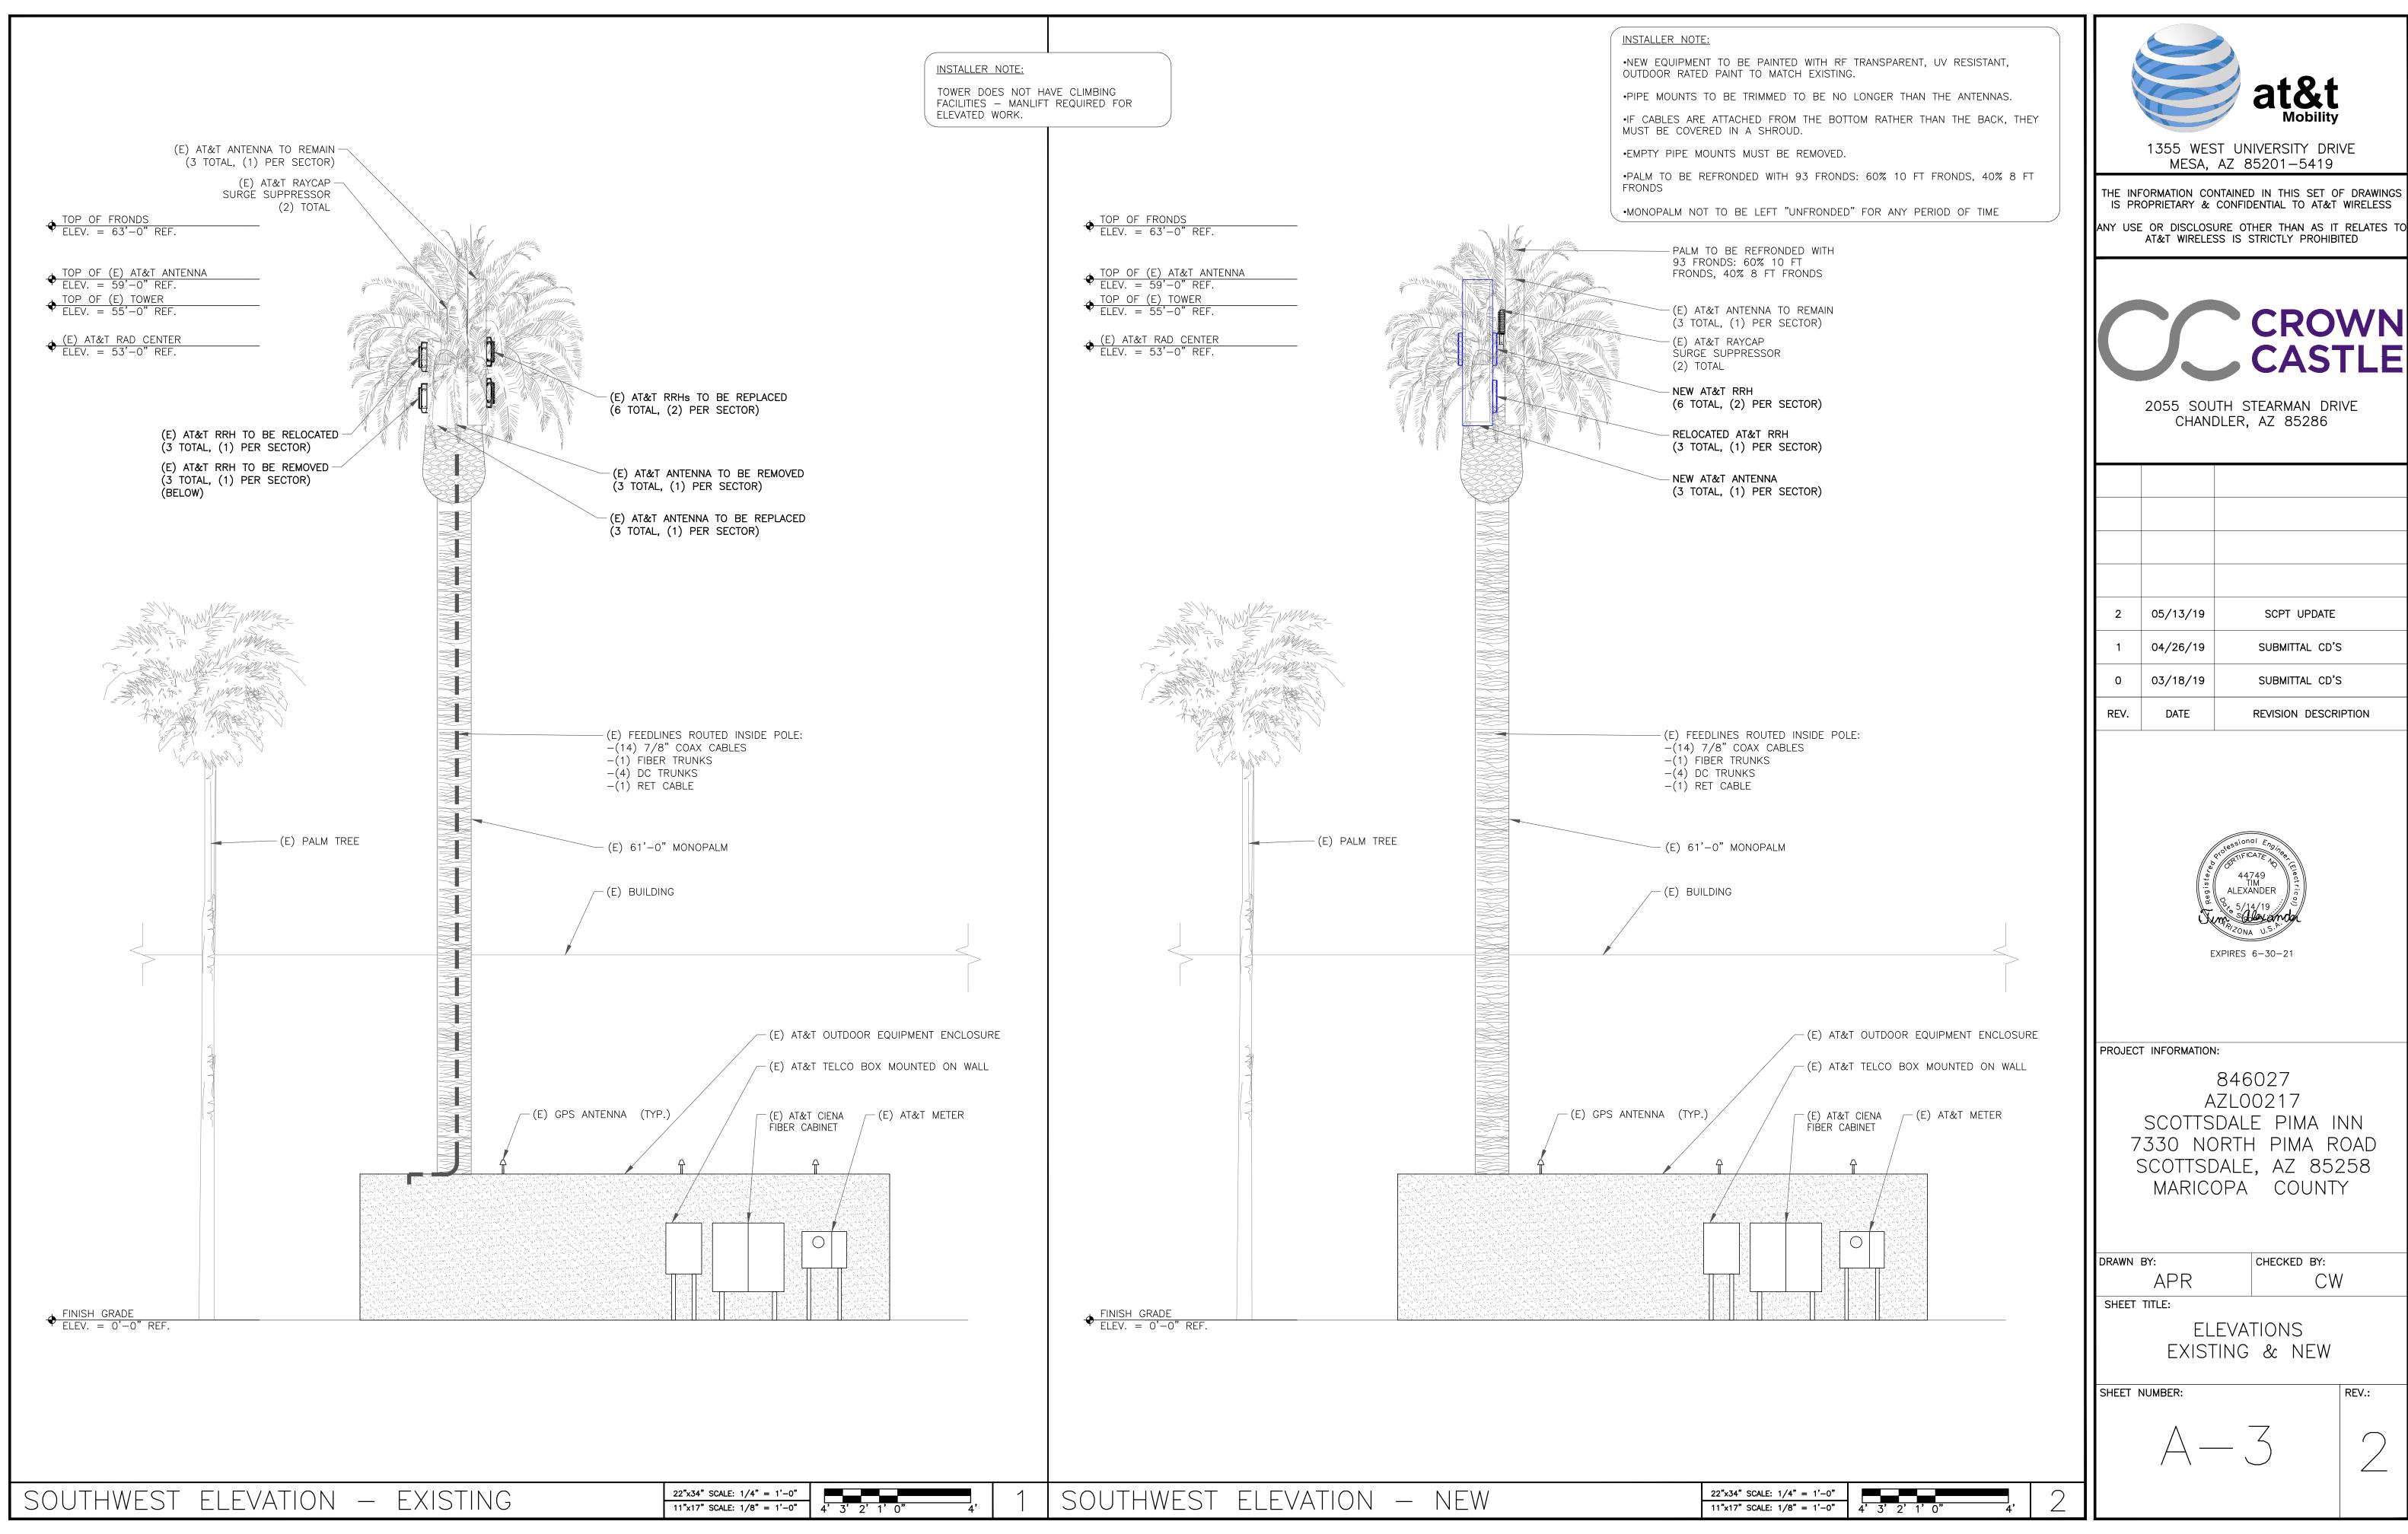

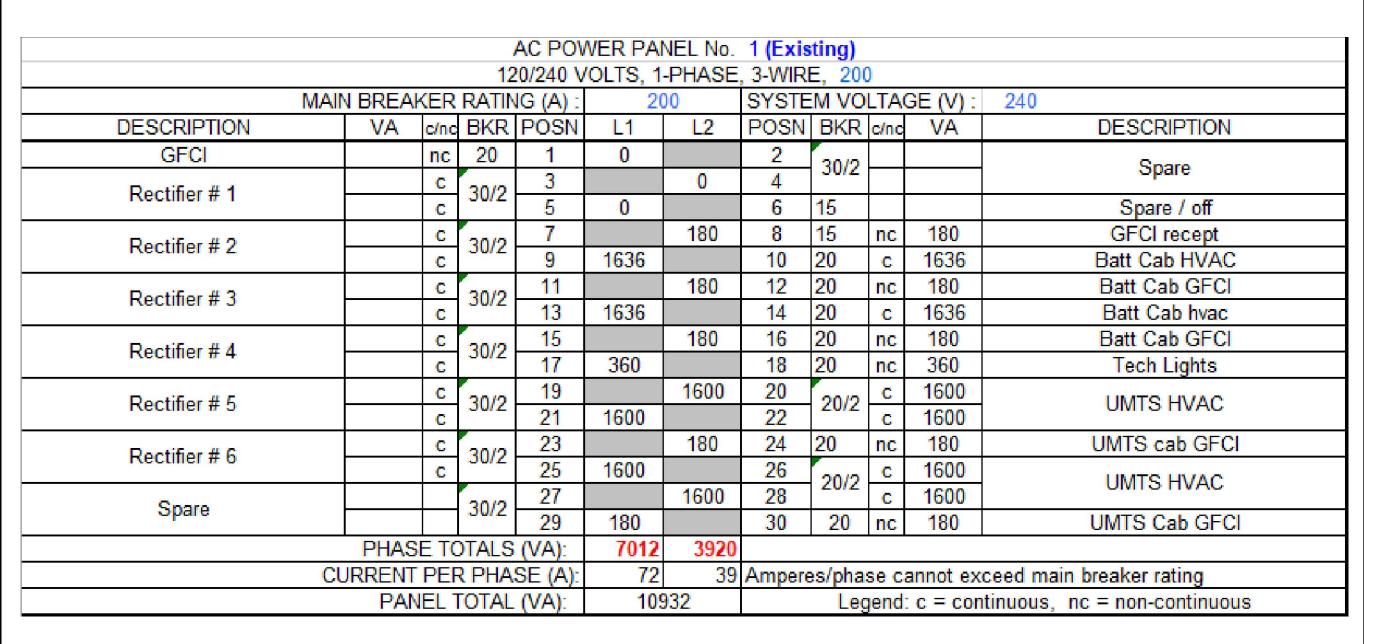

	AC POWER PANEL No. 1 (PROPOSED)  120/240 VOLTS, 1-PHASE, 3-WIRE, 200										
	MAIN BREAKER RATING (A) :							EM VOI	240		
DESCRIPTION				PÒŚN	L1	L2	<u> </u>	BKR			DESCRIPTION
GFCI	180	nc	20	1	180		2	30/2			Spara
Rectifier # 1 & 2	1725	С	30/2	3		1725	4	30/2			Spare
Rectiller # 1 & Z	1725	С	30/2	5	1725		6	15			Spare / off
Rectifier # 3 & 4	1725	С	30/2	7		1905	8	15	nc	180	GFCI recept
Nectillel # 3 & 4	1725	С	JUIZ	9	3361		10	20	C	1636	Batt Cab HVAC
Rectifier # 5 & 6	1725	С	30/2	11		1905	12	20	nc	180	Batt Cab GFCI
Nectiller # 5 & 0	1725	5 с	30/2	13	3361		14	20	C	1636	Batt Cab hvac
Rectifier # 7 & 8	1725	С	30/2	15		1905	16	20	nc	180	Batt Cab GFCI
Rectiller # / & o	1725	С	30/2	17	2085		18	20	nc	360	Tech Lights
Spare / off			30/2	19		1600	20	20/2	C	1600	UMTS HVAC
Spare / off			30/2	21	1600		22	2012	C	1600	OIVITS TIVAC
Spare / off			30/2	23		180	24	20	nc	180	UMTS cab GFCI
Spare / off			30/2	25	1600		26	20/2	C	1600	UMTS HVAC
Spara / off	'		30/2	27		1600	28	2012	C	1600	UNITS FIVAC
Spare / off	1		30/2	29	180		30	20	nc	180	UMTS Cab GFCI
	PHASE TOTALS (VA):				14092	10820					
	CURRENT PER PHASE (A):				145	111	Amperes/phase cannot exceed main breaker rating				
	PANEL TOTAL (VA):					912	Legend: c = continuous, nc = non-continuous				

AT&T WIRELESS IS STRICTLY PROHIBITED 05/13/19 04/26/19

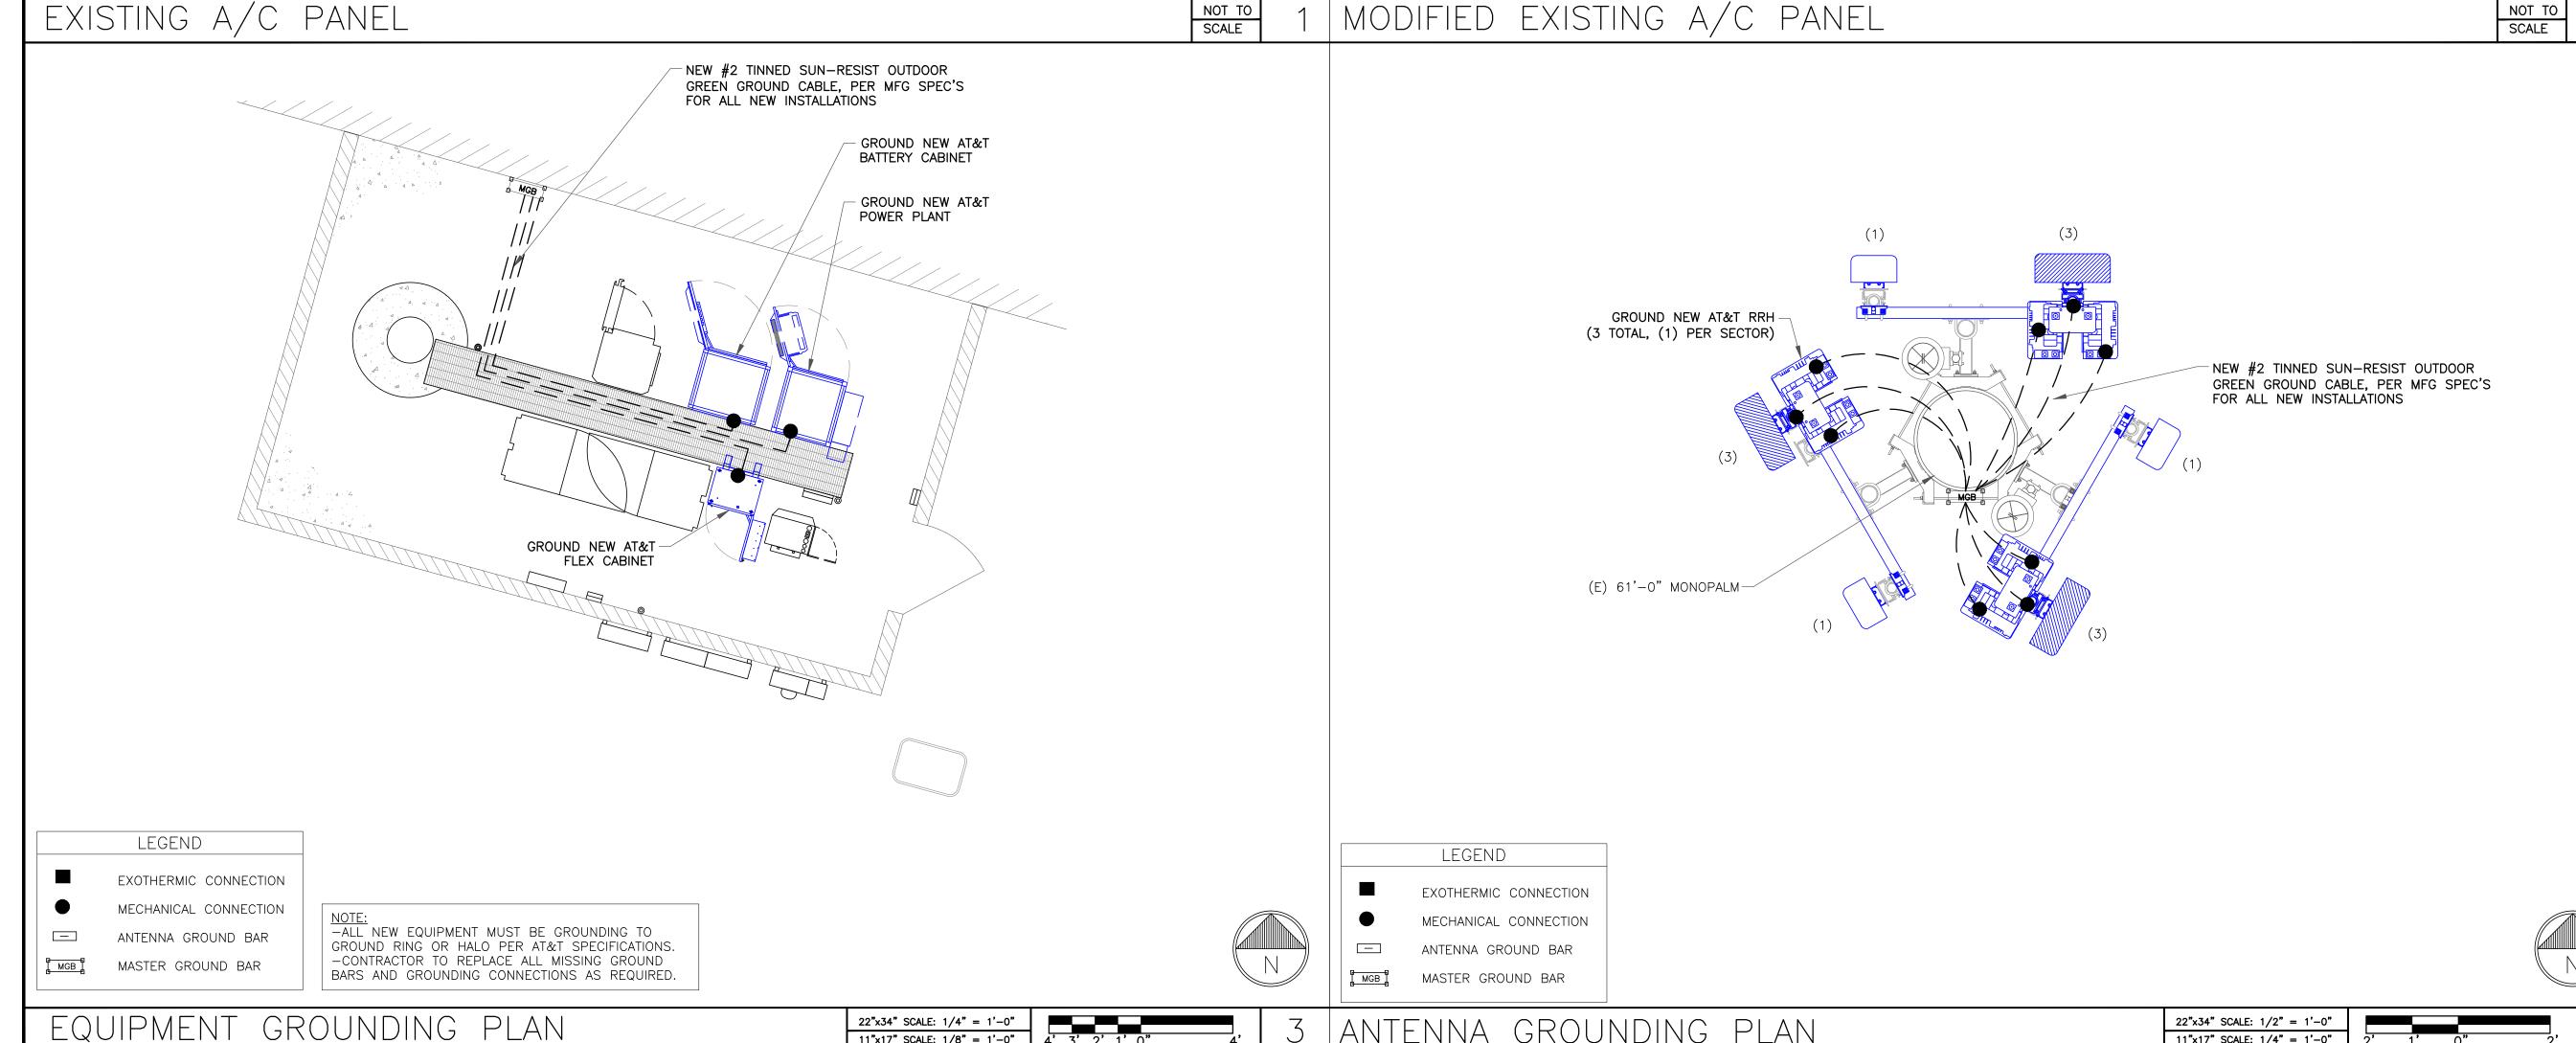

at&t

1355 WEST UNIVERSITY DRIVE MESA, AZ 85201-5419

THE INFORMATION CONTAINED IN THIS SET OF DRAWINGS IS PROPRIETARY & CONFIDENTIAL TO AT&T WIRELESS ANY USE OR DISCLOSURE OTHER THAN AS IT RELATES T



2055 SOUTH STEARMAN DRIVE CHANDLER, AZ 85286

SCPT UPDATE SUBMITTAL CD'S 03/18/19 SUBMITTAL CD'S REV. REVISION DESCRIPTION



PROJECT INFORMATION:

846027 AZL00217 SCOTTSDALE PIMA INN 7330 NORTH PIMA ROAD SCOTTSDALE, AZ 85258 MARICOPA COUNTY

DRAWN BY: CHECKED BY: APR CW

SHEET TITLE: ELECTRICAL PANEL


& GROUNDING PLAN

SHEET NUMBER:

05/17/2019

REV.:

11"x17" SCALE: 1/8" = 1'-0"

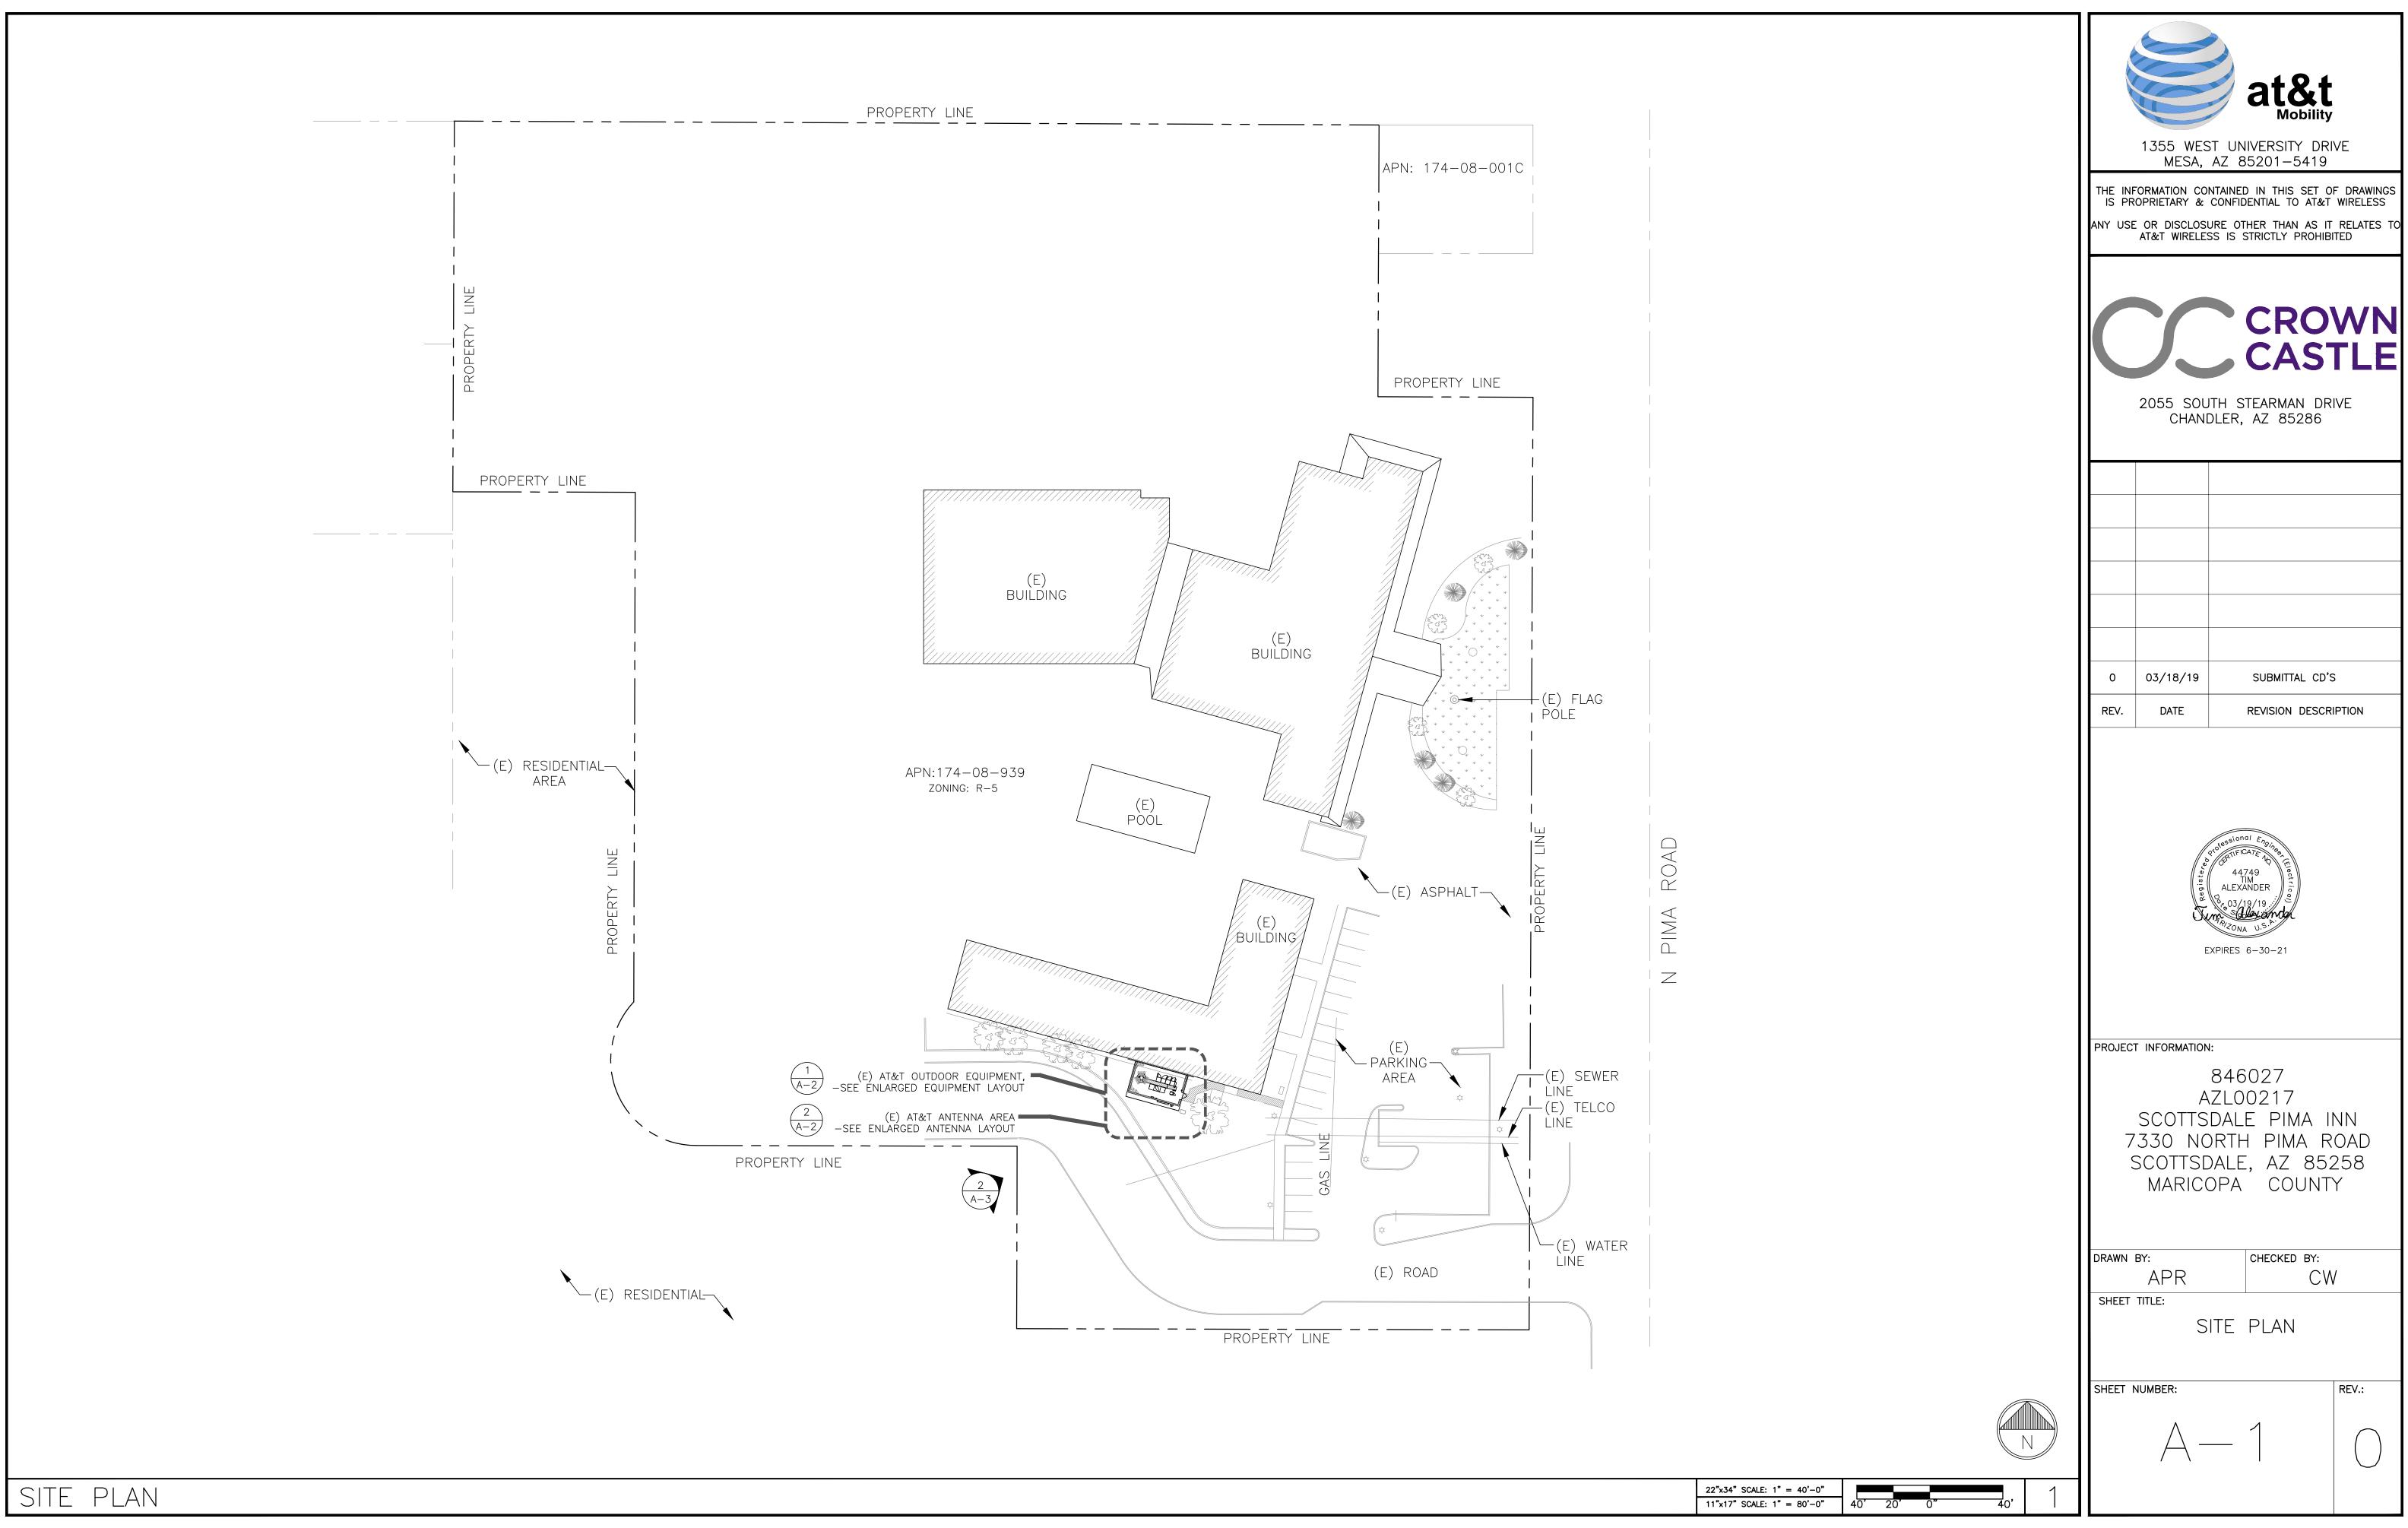

# PROJECT TEAM

# PROJECT OWNER

1355 WEST UNIVERSITY DRIVE ADDRESS: CITY, STATE, ZIP: MESA, AZ 85201-5419

SAQ CONTACT NAME: CONSTRUCTION CONTACT NAME:

2000 CORPORATE DRIVE CITY, STATE, ZIP: CANONSBURG, PA 15317

CROWN CASTLE SITE NAME: SCOTTSDALE PIMA INN SCOTTSDALE PIMA INN BU NUMBER: APPLICATION NUMBER: 482635

APPLICATION PROJECT MANAGER: GABRIEL DALEY (480) 735-6929 ANDREW MAGOON (602) 845-1783 AE PROJECT MANAGER: TROY BOSWORTH (480) 735-6905 CONSTRUCTION MANAGER:

TELCYTE INFRASTRUCTURE SERVICES 2227 W. PECOS ROAD SUITE 4

CITY, STATE, ZIP: CHANDLER, AZ 85227 cwolfe@telcyte.com

# **REFERENCE DOCUMENTS:**

STRUCTURAL ANALYSIS: Paul J. Ford & Company

MOUNT ANALYSIS: BY OTHERS

# **INSTALLER NOTE:**

LATITUDE:

LONGITUDE:

LAT./LONG. TYPE:

**GROUND ELEVATION:** 

AREA OF CONSTRUCTION:

ZONING/JURISDICTION:

CURRENT ZONING:

EXISTING USE:

TOWER DOES NOT HAVE CLIMBING FACILITIES - MANLIFT REQUIRED FOR ELEVATED WORK.

# GENERAL NOTES

# DO NOT SCALE DRAWINGS

CONTRACTOR SHALL VERIFY ALL PLANS AND EXISTING DIMENSIONS AND CONDITIONS ON THE JOB SITE AND SHALL IMMEDIATELY NOTIFY THE ARCHITECT/ENGINEER IN WRITING OF ANY DISCREPANCIES BEFORE PROCEEDING WITH THE WORK OR BE RESPONSIBLE FOR

FACILITY IS UNMANNED AND NOT FOR HUMAN HABITATION. A TECHNICIAN WILL VISIT THE SITE AS REQUIRED FOR ROUTINE MAINTENANCE. THE PROJECT WILL NOT RESULT IN ANY SIGNIFICANT DISTURBANCE OR EFFECT ON DRAINAGE: NO SANITARY SEWER SERVICE. POTABLE WATER, OR TRASH DISPOSAL IS REQUIRED AND NO COMMERCIAL SIGNAGE IS

CONTACT INSPECTION DEPARTMENT IN SCOTTSDALE FOR PRE-CON MEETING.

PRE-CONSTRUCTION MEETING REQUIRED, CONTACT CITY OF SCOTTSDALE INSPECTION SERVICES 480-312-5796.

SITE INFORMATION

33.5442472

1299.2' MSL

174-08-939

NAD 83


**EXISTING** 

-111.8923528

# AZL00217 138903/380831 344401 SCOTTSDALE PIMA INN 7330 NORTH PIMA ROAD SCOTTSDALE, AZ 85258

FA: 10091225 USID: 10785

PTN: 3901A0J39V 4TX4RX, 3901A0J3BW 4TX4RX, 3901A0J32E BWE, 3901A0BC3R LTE 5C - AZL00217

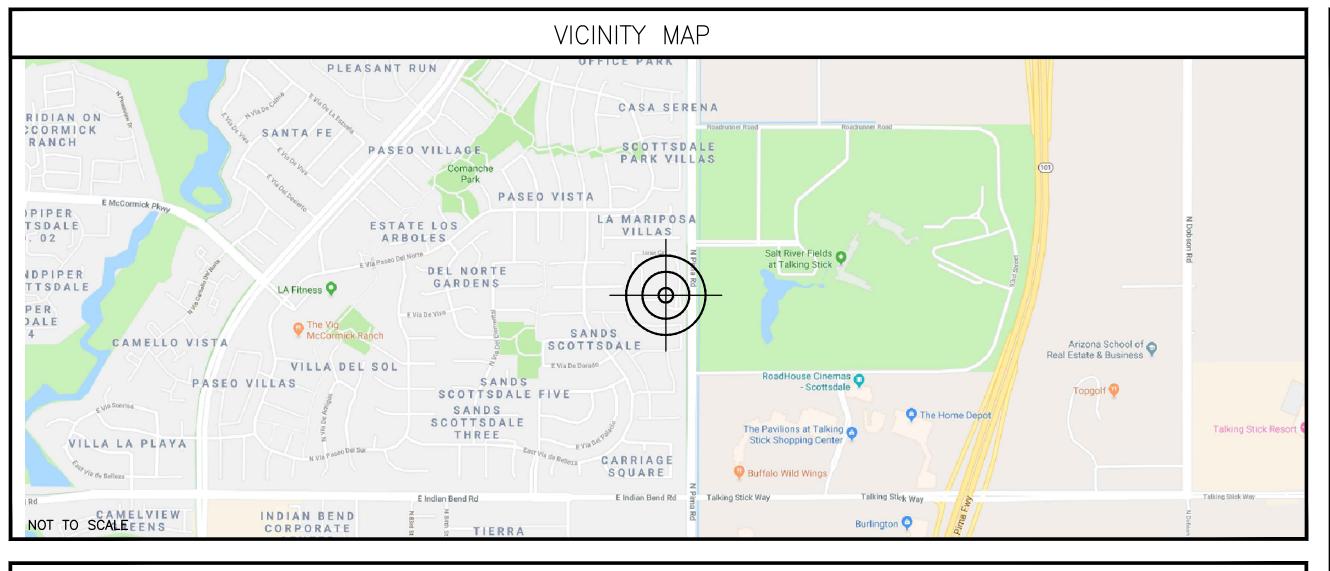

# DRIVING DIRECTIONS

FROM AT&T OFFICE: 1355 WEST UNIVERSITY DRIVE, MESA, AZ 85201-5419: HEAD EAST TOWARD W UNIVERSITY DR 226 FT, TURN LEFT TOWARD W UNIVERSITY DR 131 FT, TURN LEFT ONTO W UNIVERSITY DR 1.8 MI, TURN RIGHT ONTO N PRICE RD 0.5 MI, USE THE MIDDLE 2 LANES TO TAKE THE RAMP ONTO AZ-101 LOOP N 0.3 MI, MERGE ONTO AZ-101 LOOP N 7.0 MI, TAKE EXIT 44 FOR INDIAN BEND RD 0.3 MI, USE THE LEFT 2 LANES TO TURN LEFT ONTO TALKING STICK WAY 0.6 MI, TURN RIGHT ONTO N PIMA RD 0.4 MI, TURN LEFT ONTO INNER CIR 167 FT, TURN RIGHT TO STAY ON INNER CIR. DESTINATION WILL BE ON THE LEFT 479 FT.

# CODE COMPLIANCE

BUILDING CODE: INTERNATIONAL BUILDING CODE 2015

ELECTRICAL CODE: NATIONAL ELECTRICAL CODE 2014

THE DATE OF CONTRACT AWARD SHALL GOVERN THE DESIGN.

LIGHTNING PROTECTION CODE: NFPA 780 - 2014, LIGHTNING PROTECTION SYSTEM

SUBCONTRACTOR'S WORK SHALL COMPLY WITH ALL APPLICABLE NATIONAL, STATE, AND

LOCAL CODES AS ADOPTED BY THE LOCAL AUTHORITY HAVING JURISDICTION (AHJ) FOR

FOR ANY CONFLICTS BETWEEN SECTIONS OF LISTED CODES AND STANDARDS REGARDING

REQUIREMENT SHALL GOVERN. WHERE THERE IS CONFLICT BETWEEN A GENERAL

MATERIAL, METHODS OF CONSTRUCTION, OR OTHER REQUIREMENTS, THE MOST RESTRICTIVE

REQUIREMENT AND A SPECIFIC REQUIREMENT, THE SPECIFIC REQUIREMENT SHALL GOVERN.

THE LOCATION. THE EDITION OF THE AHJ ADOPTED CODES AND STANDARDS IN EFFECT O

MARICOPA COUNTY

HANDICAP REQUIREMENTS: FACILITY IS UNMANNED AND NOT FOR HUMAN HABITATION. HANDICAPPED ACCESS NOT REQUIRED.

CITY OF SCOTTSDALE

UNMANNED TELECOMMUNICATIONS FACILITY



CALL ARIZONA ONE CALL (800) 782-5348 CALL 3 WORKING DAYS BEFORE YOU DIG!



# RFDS DATA

DESIGN PACKAGE BASED ON RF DATA SHEET RFDS NAME: AZL00217 REVISION: 1.00

ISSUED: 01/09/2019

NUMBER OF SECTORS: 3 NUMBER OF ANTENNAS: 6 NUMBER OF TMAs: 4 NUMBER OF RRHs: 9 NUMBER OF FIBER/DC SQUIDS: 1 NUMBER OF DC SQUIDS: 1 NUMBER OF OPTICAL TRUNK CABLES: 1 NUMBER OF DC TRUNK CABLES: 4 NUMBER OF RF CABLES: 14 NUMBER OF RET CABLES: NUMBER OF WCS FILTER: 1

TITLE SHEET A-1SITE PLAN **EQUIPMENT & ANTENNA LAYOUTS** A-2A-3ELEVATIONS - EXISTING & NEW E-1 ELECTRICAL PANEL & GROUNDING PLAN DRAWINGS HAVE BEEN FORMATTED FOR 22"X34"

DIAGRAMS AND DETAILS.

CONTRACTOR TO REFERENCE PACKAGE "B" FOR SCHEMATICS, WIRING

DESCRIPTION

APPROVALS

JURISDICTIONAL APPROVAL

PROJECT DESCRIPTION

REPLACE (E) POWER PLANT W/(1) NEW NETSURE 512 -48VDC POWER PLANT

& (3) EA. HE 1.5KW -48VDC/+24VDC CONVERTER MODULES [NEQ15929].

• RECONFIGURE & REUTILIZE (40) MARATHON M12V155FT BATTERIES I.E. (10)

STRINGS @ -48VDC FOR OF A TOTAL OF 9.81 HRS OF BATTERY RESERVE.

[NEQ15917] OUTFITTED WITH (9) EA. HE 2KW -48VDC RECTIFIERS [NEQ15930]

THIS PROJECT WILL BE COMPRISED OF: CHANGES ON THE EXISTING MONOPALM:

DC BREAKER;

A/C PANEL REVIEW:

• SEE PANEL SCHEDULE

• NO WORK - OUTDOOR EQUIPMENT

• REMOVE (1) ANTENNA PER SECTOR, TOTAL OF (3)

• REPLACE (1) ANTENNA PER SECTOR, TOTAL OF (3)

CHANGES IN THE EXISTING AT&T EQUIPMENT ENCLOSURE AREA

(3) 50A AIRSCALE DUAL RRH B12/14 [NEQ.00710]

(3) 50A AIRSCALE DUAL RRH B25/66 [NEQ.00710]

(3) 20A RRH 4X25 - WCS [NEQ.00466]

(2) 60A FUSE PANEL [NEQ.00711]

• INSTALL (1) EA. NEW -48VDC PURCELL FLX21 CABINET.

• REMOVE (1) RRH PER SECTOR, TOTAL OF (3)

• REPLACE (2) RRHs PER SECTOR, TOTAL OF (6)

RELOCATE (1) RRH PER SECTOR, TOTAL OF (3)

(2) 15A 7705 SIAD [NEQ.00706]

(3) 150A UMTS [NEQ.00714]

(1) 100A BBU [NEQ.00187]

LANDLORD:

DATE:

1355 WEST UNIVERSITY DRIVE MESA, AZ 85201-5419

THE INFORMATION CONTAINED IN THIS SET OF DRAWINGS IS PROPRIETARY & CONFIDENTIAL TO AT&T WIRELESS

ANY USE OR DISCLOSURE OTHER THAN AS IT RELATES AT&T WIRELESS IS STRICTLY PROHIBITED



2055 SOUTH STEARMAN DRIVE CHANDLER, AZ 85286


03/18/19 SUBMITTAL CD'S REV. REVISION DESCRIPTION





PROJECT INFORMATION:


846027 AZL00217 SCOTTSDALE PIMA INN 7330 NORTH PIMA ROAD SCOTTSDALE, AZ 85258 MARICOPA COUNTY


DRAWN BY:	CHECKED BY:
APR	CW
SHEET TITLE:	
	LE
SH	EET
SHEET NUMBER:	REV.:

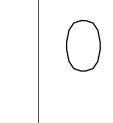

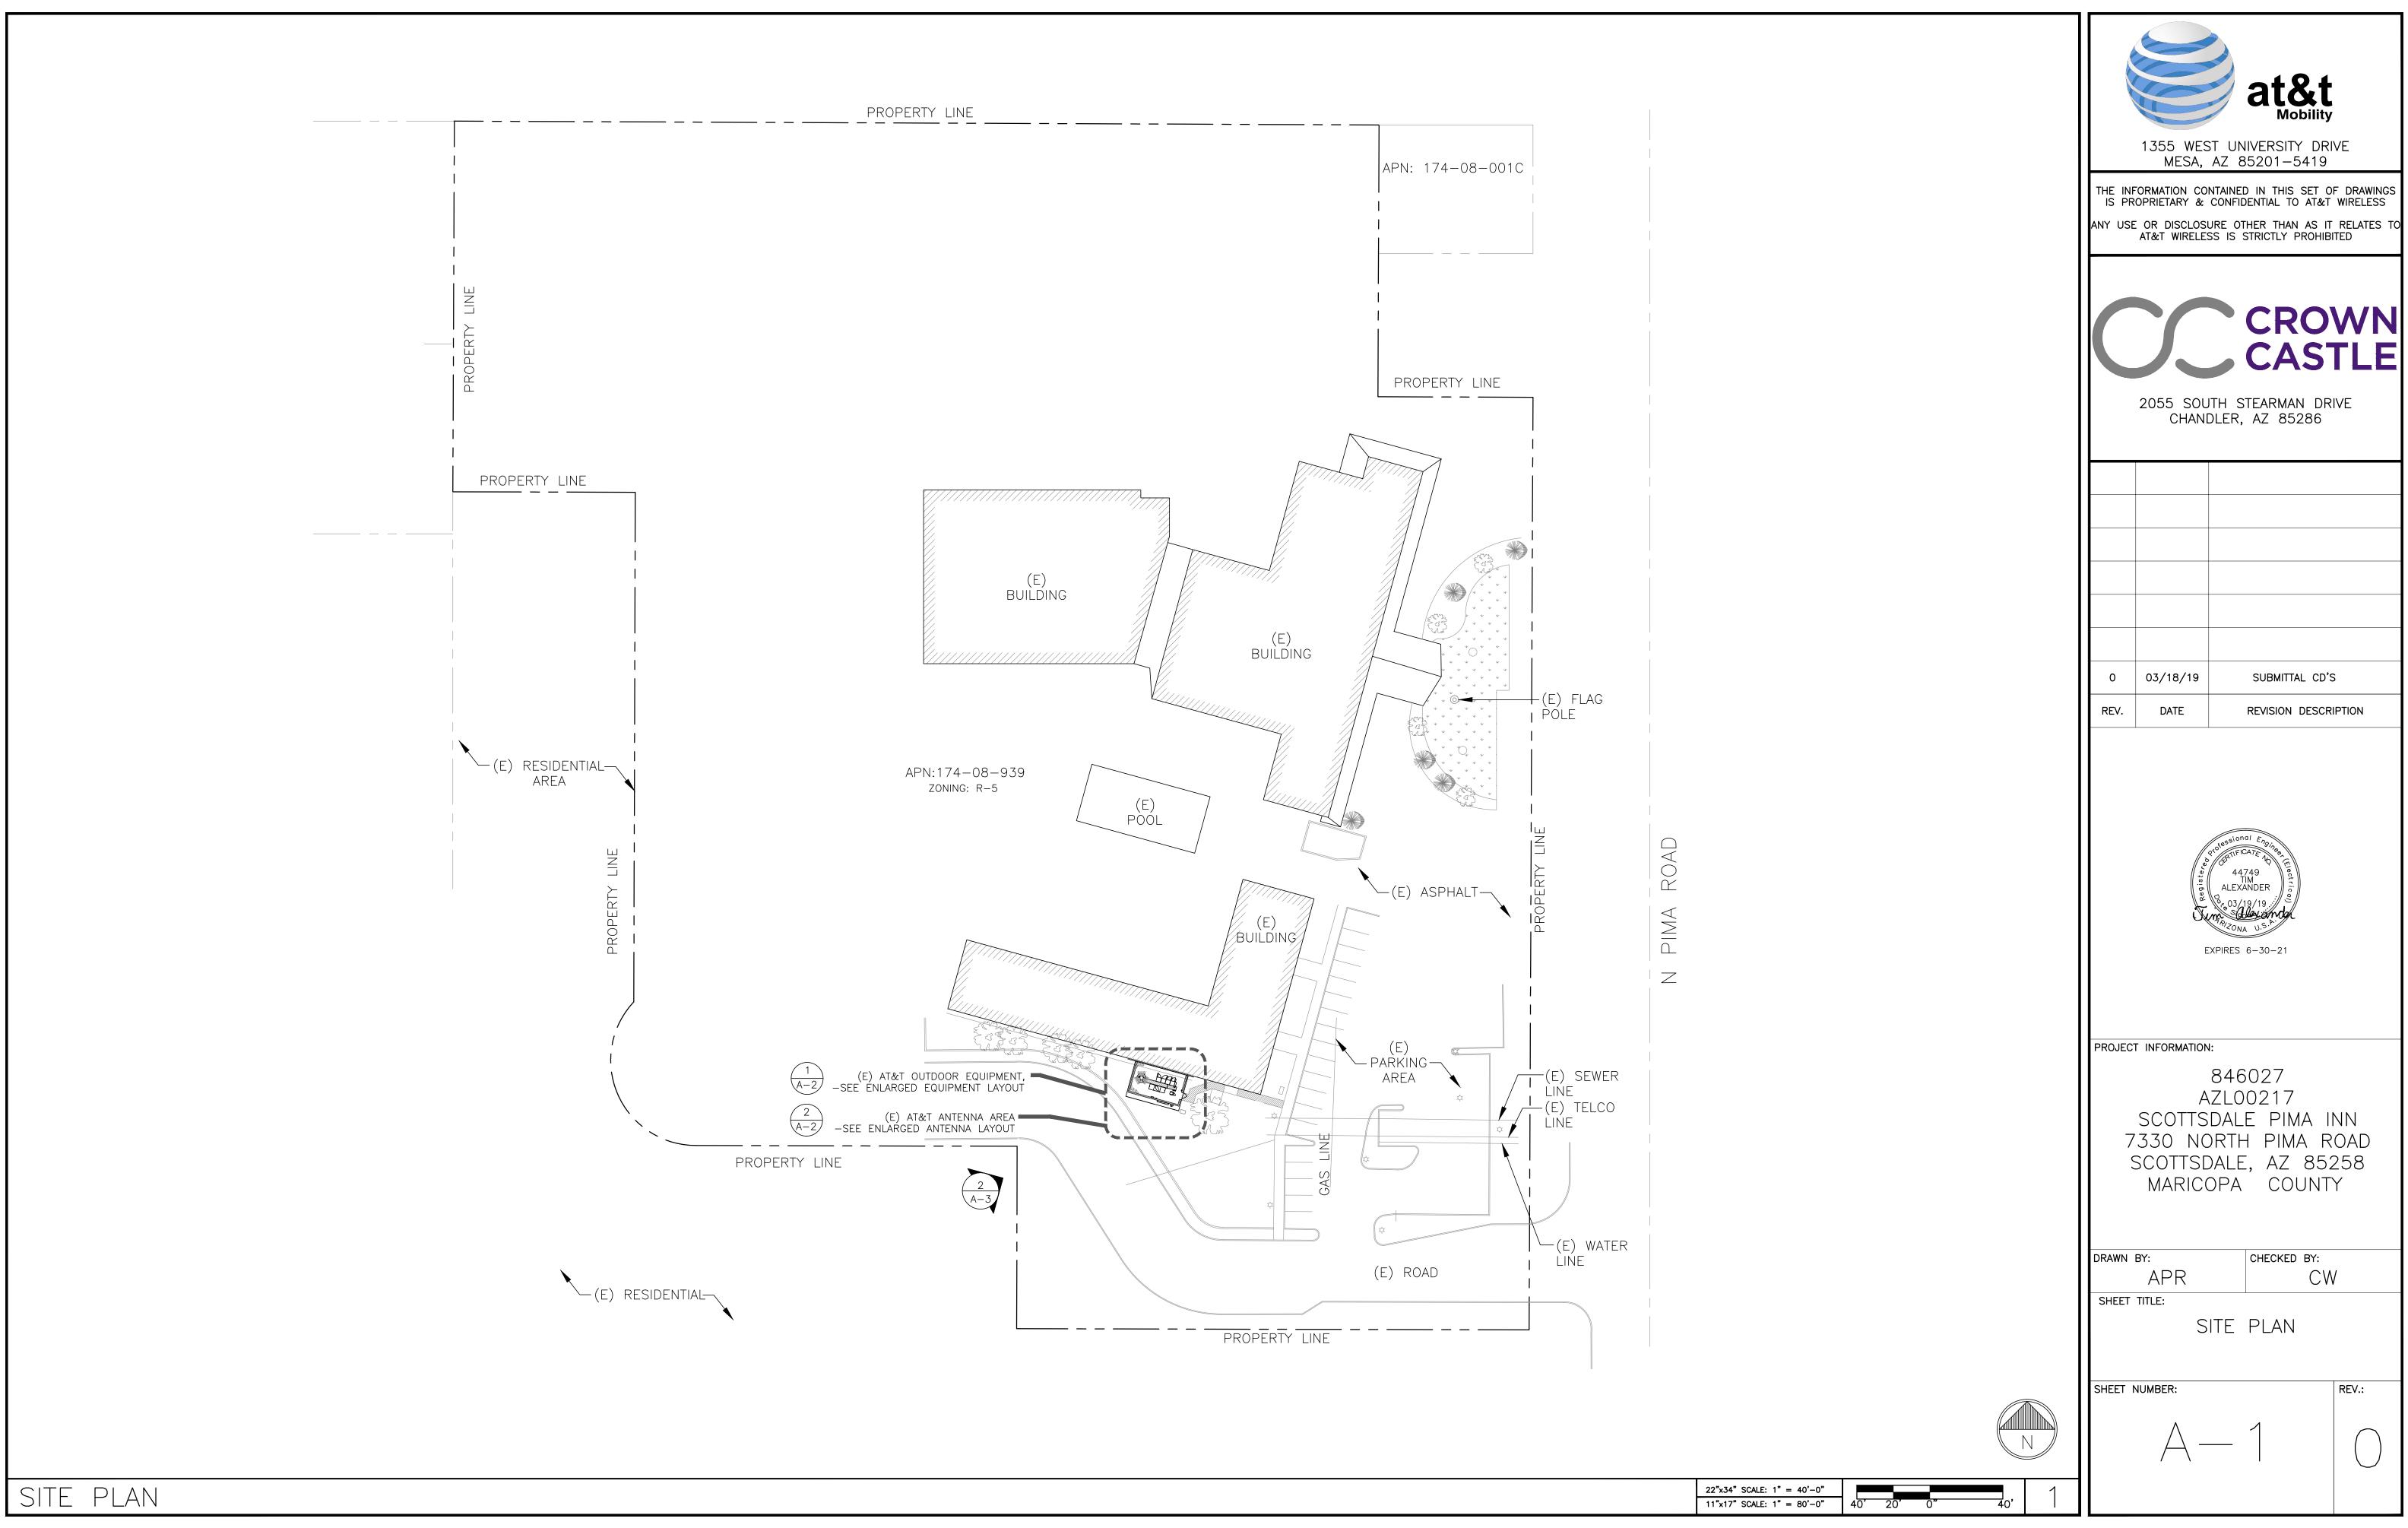

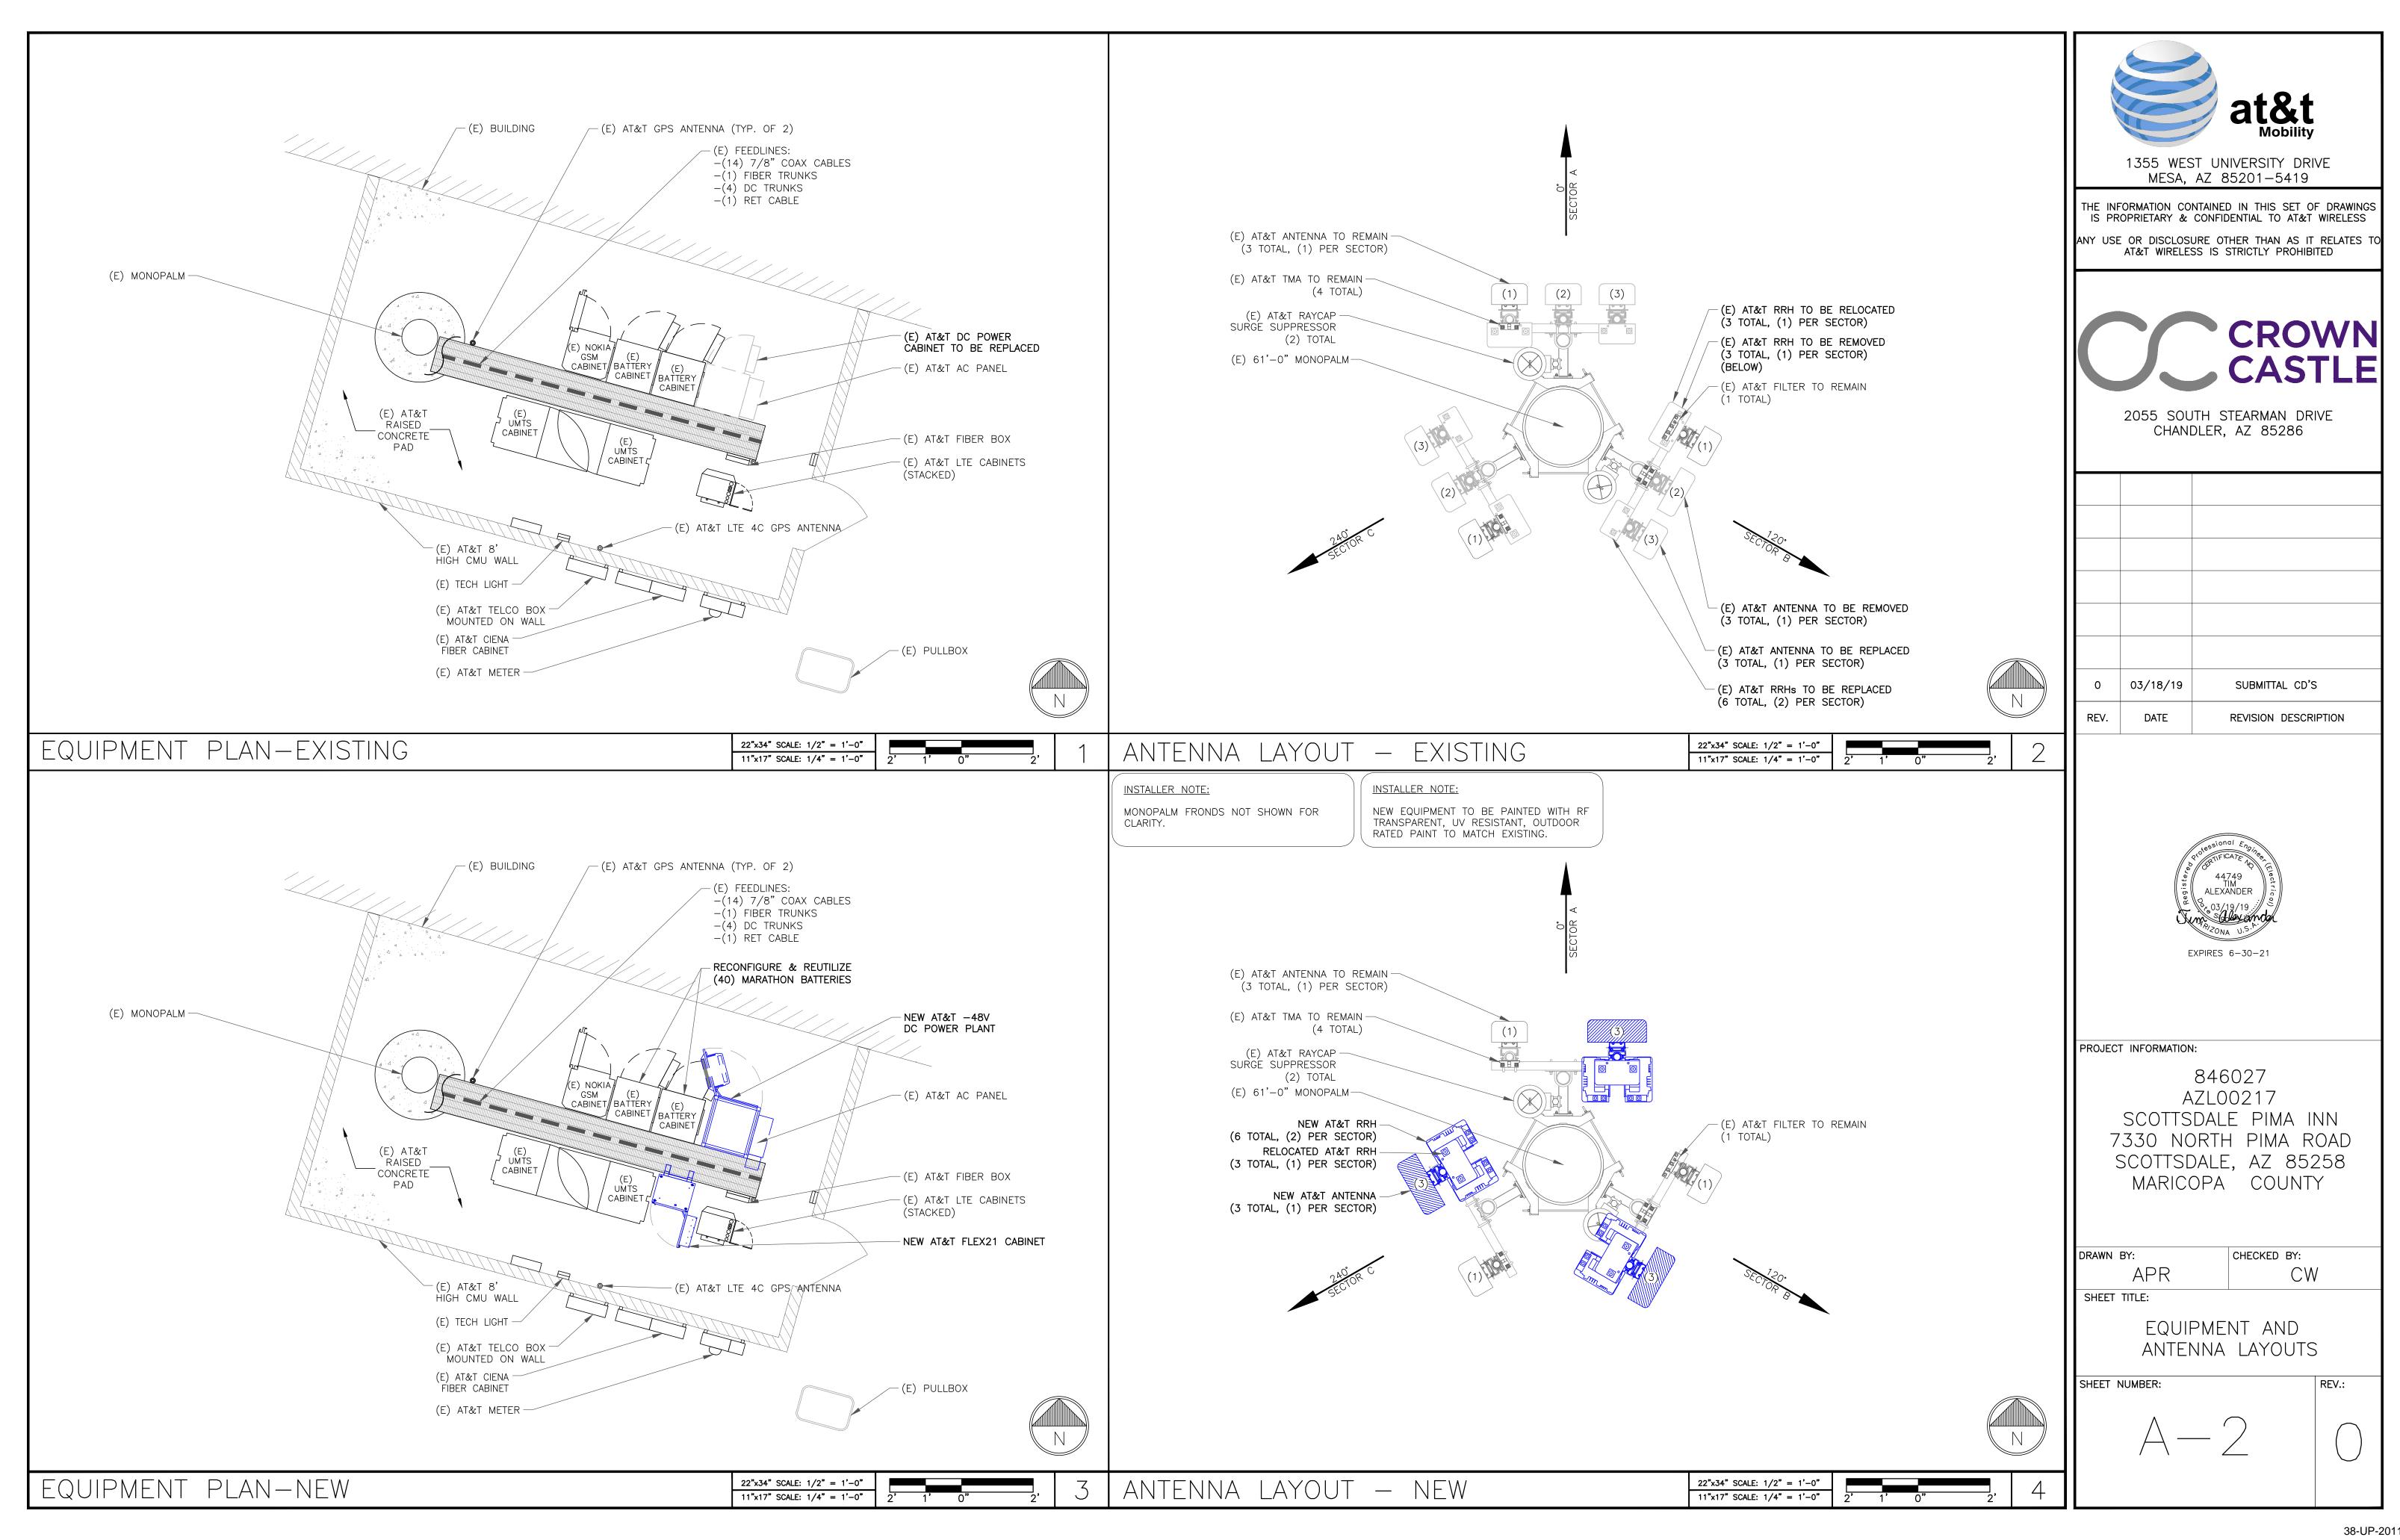

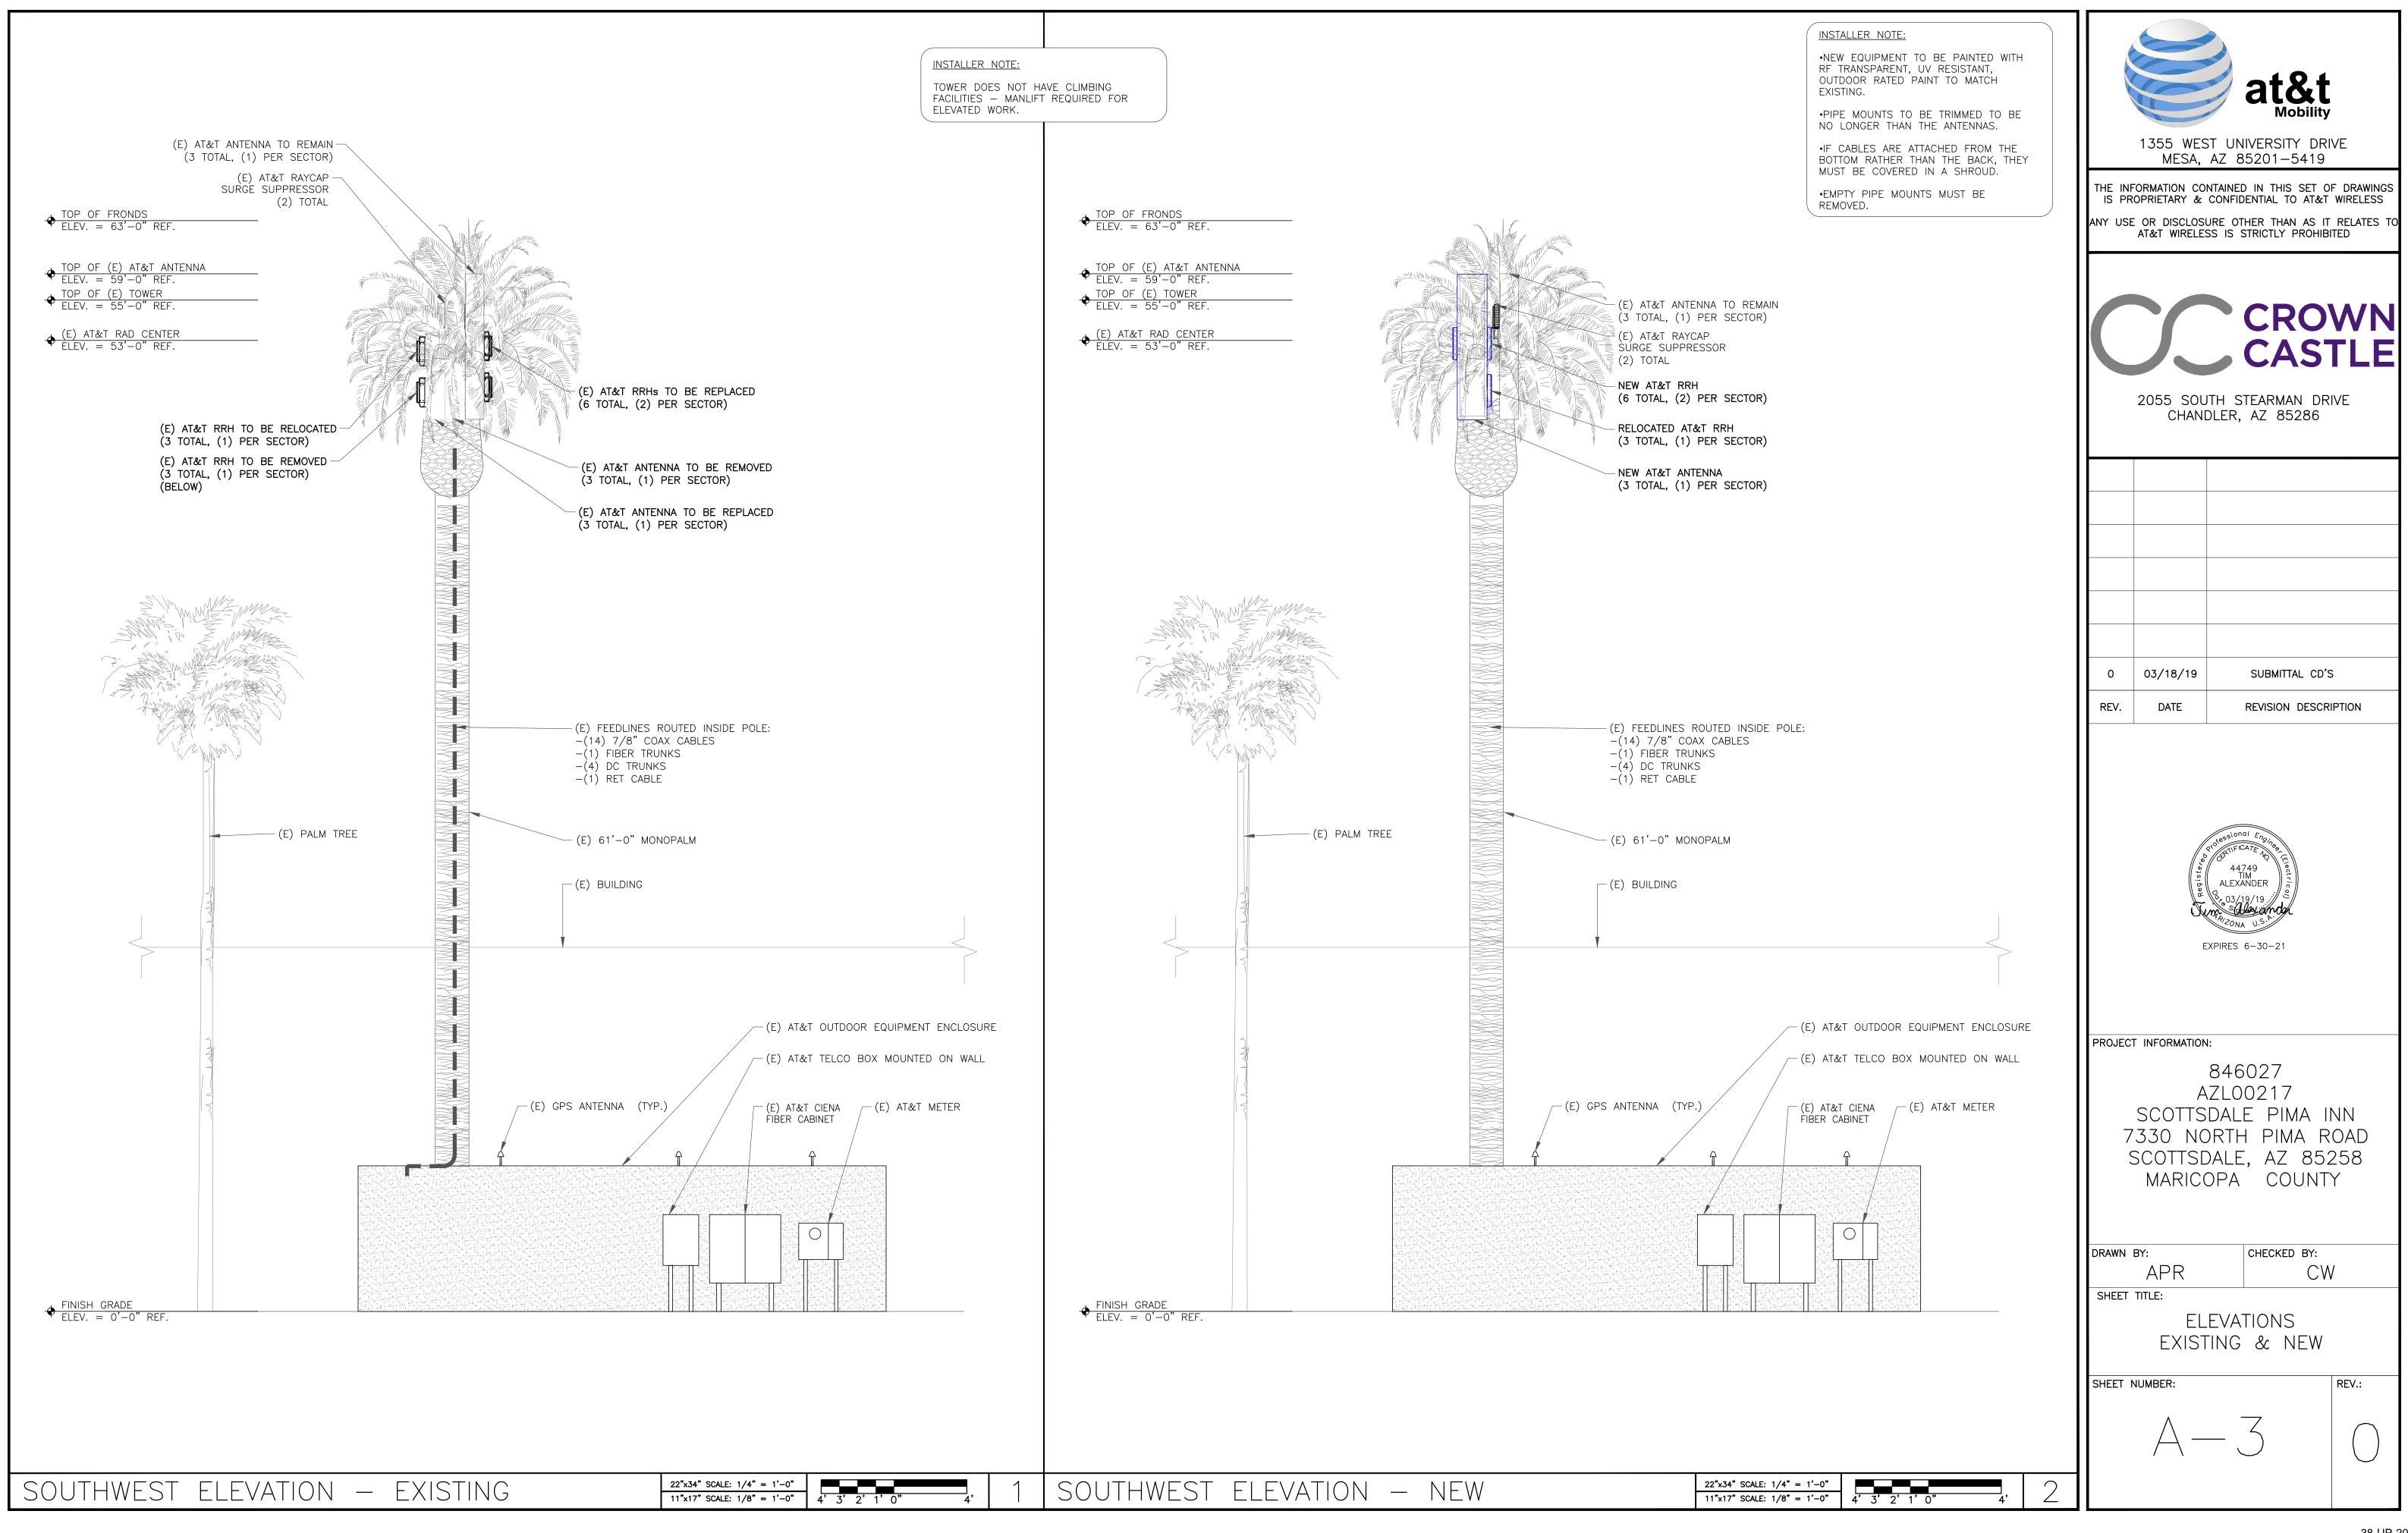

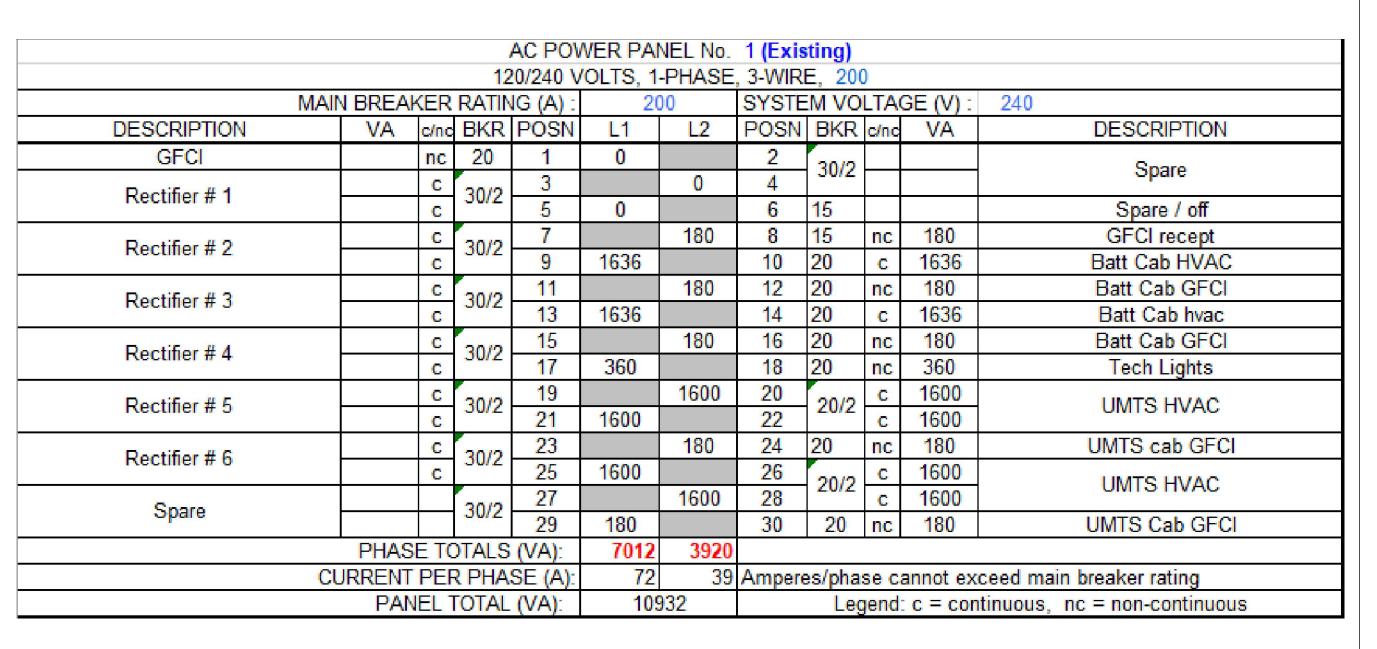

	AC POWER PANEL No. 1 (PROPOSED)										
	120/240 VOLTS, 1-PHASE, 3-WIRE, 200  MAIN BREAKER RATING (A): 200 SYSTEM VOLTAGE (V): 240										
DESCRIPTION	VA VA	N BREAKER RATING (A) :  VA c/nc BKR POSN				L2	SYSTEM VOLTAGE (V): POSN BKR c/nc VA				240 DESCRIPTION
				FUSIN	L1	LZ		DKK	c/nc	VA	DESCRIPTION
GFCI	180	nc	20	1	180	4705	2	30/2	30/2		Spare
Rectifier # 1 & 2	1725	С	30/2	3	4705	1725	4	4.5			0 / "
	1725	C		5	1725		6	15			Spare / off
Rectifier # 3 & 4	1725	C	30/2	7		1905	8	15	nc	180	GFCI recept
Trootino in o di 1	1725	C	3012	9	3361		10	20	C	1636	Batt Cab HVAC
Rectifier # 5 & 6	1725	C	30/2	11		1905	12	20	nc	180	Batt Cab GFCI
Rectiller # 5 & 0	1725	25 c	30/2	13	3361		14	20	C	1636	Batt Cab hvac
Rectifier # 7 & 8	1725	С	30/2	15		1905	16	20	nc	180	Batt Cab GFCI
Rectiller # 7 & 0	1725	C	30/2	17	2085		18	20	nc	360	Tech Lights
Spare / off			30/2	19		1600	20	20/2	С	1600	UMTS HVAC
Spare / off			30/2	21	1600		22	20/2	С	1600	OWITS HVAC
Spara / off		20/0	30/2	23		180	24	20	nc	180	UMTS cab GFCI
Spare / off			30/2	25	1600		26	20/2	С	1600	UMTS HVAC
Charo / off			30/2	27		1600	28	20/2	С	1600	OWITS TVAC
Spare / off			30/2	29	180		30	20	nc	180	UMTS Cab GFCI
	PHASE TOTALS (VA):				14092	10820					
	CURRENT PER PHASE (A):					111	Amperes/phase cannot exceed main breaker rating				
	PANEL TOTAL (VA):					12	Legend: c = continuous, nc = non-continuous				



1355 WEST UNIVERSITY DRIVE MESA, AZ 85201-5419

THE INFORMATION CONTAINED IN THIS SET OF DRAWINGS IS PROPRIETARY & CONFIDENTIAL TO AT&T WIRELESS ANY USE OR DISCLOSURE OTHER THAN AS IT RELATES T

AT&T WIRELESS IS STRICTLY PROHIBITED



2055 SOUTH STEARMAN DRIVE CHANDLER, AZ 85286

0	03/18/19	SUBMITTAL CD'S

REVISION DESCRIPTION



PROJECT INFORMATION:

REV.

DATE

846027 AZL00217 SCOTTSDALE PIMA INN 7330 NORTH PIMA ROAD SCOTTSDALE, AZ 85258 MARICOPA COUNTY


DRAWN BY: CHECKED BY: APR CW

SHEET TITLE:

ELECTRICAL PANEL & GROUNDING PLAN

SHEET NUMBER:

EXISTING A/C PANEL MODIFIED EXISTING A/C PANEL NOT TO SCALE

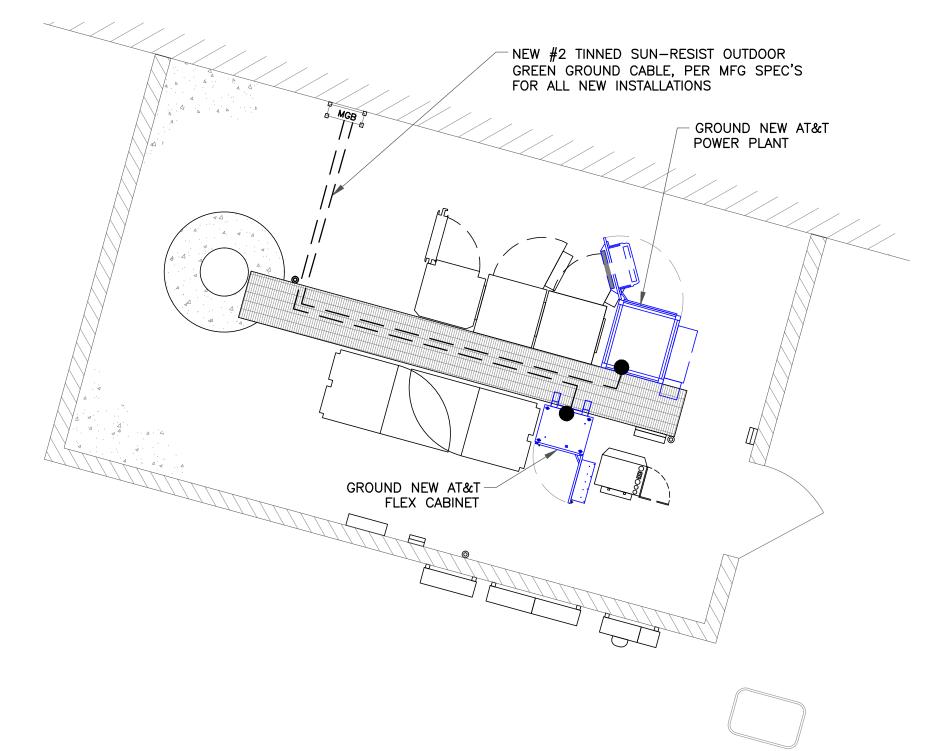

LEGEND EXOTHERMIC CONNECTION MECHANICAL CONNECTION ANTENNA GROUND BAR MASTER GROUND BAR

EQUIPMENT GROUNDING PLAN

NOTE:
-ALL NEW EQUIPMENT MUST BE GROUNDING TO
GROUND RING OR HALO PER AT&T SPECIFICATIONS.

-CONTRACTOR TO REPLACE ALL MISSING GROUND

BARS AND GROUNDING CONNECTIONS AS REQUIRED.

LEGEND

EXOTHERMIC CONNECTION

MECHANICAL CONNECTION

ANTENNA GROUND BAR

MASTER GROUND BAR

 $22" \times 34"$  SCALE: 1/4" = 1'-0"11"x17" SCALE: 1/8" = 1'-0"

ANTENNA GROUNDING PLAN

GROUND NEW AT&T RRH (3 TOTAL, (1) PER SECTOR)

(E) 61'-0" MONOPALM-

22"x34" SCALE: 1/2" = 1'-0" 11"x17" SCALE: 1/4" = 1'-0"

NEW #2 TINNED SUN-RESIST OUTDOOR
GREEN GROUND CABLE, PER MFG SPEC'S
FOR ALL NEW INSTALLATIONS